

### AIR HANDLING UNIT KEYED NOTES:

- (1) OA MOTORIZED DAMPER WITH END SWITCH
- 2 OA TEMPERATURE SENSOR
- (3) PRE-FILTER DIFFERENTIAL PRESSURE SENSOR
- 4 FREEZE STAT
- (5) V-1 STEAM HEATING CONTROL VALVE (WITH POSITION INDICATOR)
- (6) CURRENT SWITCH FOR FAN STATUS
- 7 V-2 HUMIDIFIER CONTROL VALVE (WITH POSITION INDICATOR)
- (8) RF MOTORIZED DAMPER (WITH END SWITCH)
- 9 SPACE TEMPERATURE SENSOR
- (10) SPACE HUMIDITY SENSOR
- MANUFACTURERS AND MODELS LISTED ON SCHEDULES. ANY ALTERNATE EQUIPMENT SUBMITTED SHALL MEET OR EXCEED ALL PERFORMANCE CAPACITIES AND FALL WITHIN PHYSICAL DIMENSIONS AND WEIGHTS OF SCHEDULED EQUIPMENT. ALTERNATE SUBMITTALS SHALL MEET ALL SYSTEM REQUIREMENTS. CONTRACTOR SHALL BE RESPONSIBLE FOR ALL MODIFICATIONS (STRUCTURAL, ELECTRICAL, MECHANICAL, ETC.) NECESSARY TO ACCOMMODATE ALTERNATE EQUIPMENT AT NO ADDITIONAL COST TO THE OWNER.

### **GENERAL NOTES** 1. MECHANICAL CONTRACTOR SHALL COORDINATE WORK WITH

- EXISTING CONDITIONS AND WITH THE WORK OF OTHER TRADES. 2. THESE DRAWINGS ARE A DIAGRAMMATIC REPRESENTATION OF WORK TO BE ACCOMPLISHED AND AS SUCH DO NOT SHOW ALL REQUIRED OFFSETS OF PIPING. MECHANICAL CONTRACTOR
- THE STRUCTURE, EQUIPMENT CONNECTIONS AND MAINTAIN HEADROOM AND PASSAGEWAY.
- 3. ALL CUTTING AND PATCHING OF EXISTING STRUCTURE TO ACCOMMODATE NEW HVAC IS BY MECHANICAL CONTRACTOR. 4. MECHANICAL CONTRACTOR IS RESPONSIBLE FOR REMOVAL

AND REINSTALLATION OF EXISTING CEILING (UNLESS WORK

PERFORMED BY GENERAL CONTRACTOR AND IDENTIFIED ON ARCHITECTURAL DRAWINGS.) REPLACE ALL DAMAGED CEILING

SHALL INSTALL MATERIAL AND EQUIPMENT AS TO CONFORM TO

- 5. KEYNOTES PERTAIN ONLY TO THE DRAWING THEY ARE
- 6. DUCT SIZES ARE CLEAR INSIDE DIMENSIONS.
- 7. MECHANICAL CONTRACTOR SHALL CLEAN ALL NEW DUCTWORK, COILS AND DIFFUSERS THAT ARE WITHIN PROJECT LIMITATIONS PRIOR TO COMPLETION.
- 8. ALL CONTROL WIRING SHALL BE RUN IN CONDUIT.
- 9. MAINTAIN 10' MINIMUM DISTANCE FROM OUTSIDE AIR INTAKE TO ANY EXHAUST OR TOILET VENTS.
- 10. ALL EQUIPMENT, DUCTWORK AND PIPING FITTINGS SHALL BE INSTALLED IN A MANNER WHICH VA STAFF SHALL HAVE ACCESS.
- 11. CONTRACTOR SHALL NOT PERFORM ANY WORK OUTSIDE THE CONSTRUCTION BOUNDARY LIMITS UNLESS NOTED ON PLANS.
- COORDINATE SCHEDULE OF SUCH WORK WITH VA. 12. THE EXISTING OR DEMOLITION PLANS ARE BASED OFF OF EXISTING AS-BUILTS, CONSTRUCTION DRAWINGS & CASUAL SITE

WALK-THROUGHS. THE CONTRACTOR SHALL VISIT THE SITE,

REVIEW OTHER DISCIPLINE DEMOLITION DRAWINGS & PROVIDE

EQUIPMENT FOR THE COMPLETION OF THIS PROJECT. 13. CONTRACTOR SHALL PROVIDE OFFSETS OR TRANSITIONS OF ALL DUCTWORK AND PIPING AS NECESSARY.

DISCONNECTION OR RELOCATION OF ALL NECESSARY

14. EQUIPMENT SELECTIONS ARE BASED OFF NOTED

## **HVAC LEGEND**

NEW HVAC EQUIPMENT EXISTING DUCTWORK **NEW DUCTWORK** EXISTING MECHANICAL COMPONENT

DEMOLISHED MECHANICAL COMPONENT SUPPLY AIR DUCT UP SUPPLY AIR DUCT DOWN

RETURN AIR DUCT UP RETURN AIR DUCT DOWN EXHAUST AIR DUCT UP

EXHAUST AIR DUCT DOWN (re ) ELBOW WITH TURNING VANES FLEX DUCT

MOTORIZED DAMPER BACK DRAFT DAMPER BALANCING DAMPER AIR FLOW INDICATOR

DOOR UNDER CUT NEW SUPPLY DIFFUSER NEW RETURN/EXHAUST GRILLE

NEW RETURN/EXHAUST GRILLE WITH DAMPER **HUMIDITY SENSOR** 


THERMOSTAT DUCT SMOKE DETECTOR

CONTROL WIRE KEY NOTE

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DEMO NOTE

## PIPING LEGEND

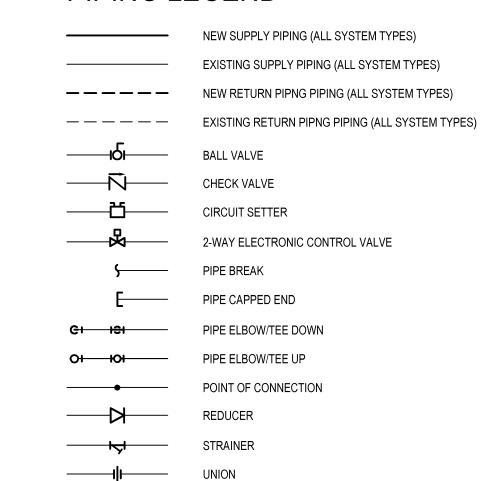

### **ABBREVIATIONS**

AD — ACCESS DOOR — ABOVE FINISHED FLOOR — ACCESS PANEL BOD — BOTTOM OF DUCT — BOTTOM OF PIPE — CONDENSATE DRAIN — CUBIC FEET PER MINUTE — CONTROL PANEL — CONDENSATE DRAIN — DOWN — EXHAUST AIR — MINIMUM — MAXIMUM LPS — LOW PRESSURE STEAM

— OUTSIDE AIR

— RETURN AIR

S/D — START / DISCONNECT

SA — SUPPLY AIR

— LOW PRESSURE CONDENSATE RETURN

100% CONSTRUCTION DOCUMENTS Project Title
Middleton VAH Drawing Title Office of MECHANICAL GENERAL NOTES, 607-13-101 Construct Pharmacy Cache LEGENDS, CONTROL DIAGRAM Construction Building Number AND POINTS and Facilities Approved: Project Director Drawing Number Management Madison, WI M001 Checked Department of Veterans Affairs TJK CDW

## PACKAGED ROOFTOP AIR HANDLING UNIT NO SCALE

SYSTEM CONSISTS OF A CONSTANT VOLUME AIR HANDLING UNIT AND RELIEF FAN. AIR HANDLING UNIT CONSISTS OF: SUPPLY FAN, DX COOLING COIL, STEAM HEATING COIL, HOT GAS REHEAT COIL AND MERV 8 & MERV 13 FILTERS.

SUPPLEMENTAL SUB-SYSTEMS ARE: STEAM HUMIDIFIER AND RELIEF FAN. AIR HANDLING UNIT CONTROLLER SHALL NOT ALLOW SIMULTANEOUS HEATING AND COOLING EXCEPT FOR HUMIDITY

PROVIDE ROOM THERMOSTAT, SENSORS AND OTHER CONTROL COMPONENTS IN ACCORDANCE WITH THE DDC CONTROL POINTS LIST.

SYSTEM SHOULD BE EXTENSION OF THE EXISTING TRIDIUM BAS CONTROL UTILIZING BACNET CONTROL DEVICES WITH FULL INTEGRATION WITH EXISTING OPERATOR INTERFACE. PROVIDE NEW GRAPHICS, TREND LOGS, ETC.

### AIR HANDLING UNIT OPERATION

START/STOP SUPPLY FAN. SUPPLY FAN SHOULD RUN CONTINUOUSLY.

### RELIEF FAN OPERATION

CONSTRUCT PHARMACY CACHE PROJECT

SYSTEM: RF-147

POINT DESCRIPTION

CONTROL DAMPER

FAN STATUS

one eighth inch = one foot

0 4 8 16

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RUN RELIEF FAN SHALL BE INTERLOCKED WITH AIR HANDLING UNIT AND SHALL RUN CONTINUOUSLY. RELIEF FAN SHALL BE "OFF" WHEN AIR HANDLING UNIT IS SHUT DOWN OR WHEN START SWITCH IS MANUALLY TURNED OFF FOR MAINTENANCE.

### MECHANICAL HEATING (OA TEMPERATURE BELOW 65°F)

ON DEMAND FOR HEATING, MODULATE STEAM HEATING COIL CONTROL VALVE (V-1) TO MAINTAIN DISCHARGE AIR TEMPERATURE (T2) (RESET BASED ON SPACE TEMPERATURE). DX COOLING SYSTEM SHALL BE SHUT DOWN. WHEN SPACE TEMPERATURE IS SATISFIED FOR HEATING AND IN COOLING DEMAND, RESET DISCHARGE AIR TEMPERATURE SET POINT TO MINIMUM (55°F ADJUSTABLE). PROVIDE HIGH/LOW SPACE AND DISCHARGE AIR TEMPERATURE

### MECHANICAL COOLING (OA TEMPERATURE ABOVE 70°F)

ON DEMAND FOR COOLING, DX COOLING SHALL BE ENERGIZED AND CONDENSING UNIT COMPRESSOR SHALL MODULATE TO MAINTAIN DISCHARGE AIR TEMPERATURE (T2) (55°F ADJUSTABLE). STEAM CONTROL VALVE (V-1) AND HUMIDIFIER CONTROL VALVE (V-2) SHALL BE CLOSED. WHEN SPACE TEMPERATURE IS SATISFIED FOR COOLING, RESET DISCHARGE ARE TEMPERATURE TO MAXIMUM (72°F ADJUSTABLE). PROVIDE HIGH/LOW SPACE AND

### <u>HUMIDIFICATION</u> (SPACE HUMIDITY BELOW SET POINT)

DISCHARGE AIR TEMPERATURE ALARMS.

ACTIVATE HUMIDIFICATION ON DEMAND FROM SPACE HUMIDITY SENSORS (SET AT 35% ADJUSTABLE) MINIMUM. MODULATE STEAM CONTROL VALVE (V-2) TO MAINTAIN DISCHARGE SPACE HUMIDITY PROPORTIONAL TO DEVIATION OF SPACE HUMIDITY FROM SET-POINT. DISABLE HUMIDIFICATION DURING MECHANICAL COOLING MODE. PROVIDE DISCHARGE HUMIDITY CONTROLLER TO MAINTAIN MAXIMUM DISCHARGE AIR HUMIDITY SET AT (80% ADJUSTABLE). CLOSE STEAM CONTROL VALVE IF SUPPLY FAN IS NOT RUNNING. PROVIDE HIGH/LOW SPACE AND DISCHARGE AIR HUMIDITY ALARMS. HUMIDITY CONTROL VALVE SHALL BE INTERLOCKED WITH TEMPERATURE SWITCH ON

## CONDENSATE RETURN TO KEEP HUMIDIFIER "OFF" UNTIL CONDENSATE APPROACHES STEAM TEMPERATURE.

# INPUT/OUTPUT SUMMARY TABLE ENERGY MANAGEMENT SYSTEM FUNCTIONS

4

INPUT/OUTPUT SUMMARY TABLE HARDWARE SOFTWARE ENERGY MANAGEMENT SYSTEM FUNCTIONS CONSTRUCT PHARMACY CACHE PROJECT SYSTEM: AHU-147 POINT DESCRIPTION SUPPLY FAN (NOTE 1) SCHARGE AIR SENSOR (T1 & T2 SCHARGE HUMIDITY SENSOR (H1) ITSIDE AIR SPACE TEMPERATURE SPACE HUMIDITY MOTORIZED DAMPERS (RF AND OA) HEATING VALVE (V-1) HUMIDIFIER VALVE (V-2) HUMIDIFIER CONDENSATE RETURN FILTER (NOTE 1) REEZE STAT IOT GAS REHEAT (NOTE 1 'ARIABLE SPEED COMPRESSOR (NOTE 1) NOTE 1: AVAILABLE FROM AHU CONTROL BOARD

<u>DEHUMIDIFICATION</u> (SPACE HUMIDITY ABOVE SET POINT)

SAFETY (SYSTEMS SHUT-DOWNS)

DAMPERS AND CLOSE ALL CONTROL VALVES.

COOLING AND HOT GAS REHEAT TO MAINTAIN SPACE TEMPERATURE AND HUMIDITY.

ON DEMAND FOR DEHUMIDIFICATION (BASED ON SPACE HUMIDITY SENSOR) INTERNAL CONTROL SHALL ACTIVATE

SHUT DOWN AIR HANDLER ON THE FAILURE OF THE MAJOR COMPONENTS SUCH AS SUPPLY OR RELIEF FAN AND

DURING SHUT-DOWN, SHUT-DOWN SUPPLY AND RELIEF FANS, CLOSE OUTSIDE AIR DAMPERS, CLOSE RELIEF AIR

IF SPACE TEMPERATURES ARE OUTSIDE HIGH/LOW LIMIT SET POINTS, SYSTEM SHALL SHUTDOWN.

AHU-147 POINTS LIST

CONSULTANTS:

HARDWARE

p 262.641.0746 f 888.600.6207 **a r c h i t e c t s** 

ARCHITECT/ENGINEERS:

N8 W22195 JOHNSON DR, STE 180 262.549.1190 WAUKESHA, WI 53186 fx 262.549.1620

| PLAN DESIGNATION                            | ST-1    |
|---|---------|
| MANUFACTURER                                | B&G     |
| MODEL                                       | B1-3/4" |
| SIZE  | 3/4     |
| CAPACITY - LBS/HR                           | 500     |
| PRESSURE DIFFERENTIAL - PSI                 | 1/2     |
| MAX OPERATING TEMPERATURE - F               | 406     |
| MAX OPERATING PRESSURE - PSIG               | 175     |
| SELECTION BASED ON B&G INVERTED BUCKET TRAP | -       |

| PLAN DESIGNATI  | ON       | S-1      | R-1       | E-1            |
|-----------------|----------|----------|-----------|----------------|
| MANUFACTURER    |          | TITUS    | TITUS     | TITUS          |
| MODEL           |          | 300FL    | 350FL     | 350FL          |
| CONSTRUCTION    | TYPE     | GRILLE   | GRILLE    | GRILLE         |
|                 | MOUNTING | DUCT     | DUCT      | DUCT           |
|                 | MATERIAL | ALUMINUM | ALUMINUM  | ALUMINUN       |
| CFM             |          | 300      | 1,200     | 430            |
| GRILLE SIZE     |          | 12" x 8" | 24" x 12" | 12" x 12"      |
| DUCT CONNECTION | ON SIZE  | 12" x 8" | 24" x 12" | 12" x 12"      |
| NC              |          | 17       | 28        | : <del>-</del> |
| REMARKS         |          | 1,2,3,4  | 1,2,3     | 1,2,3          |

3. PROVIDE WITH OPPOSED BLADE DAMPER

4. PROVIDE WITH 22.5 DEGREE DEFLECTION BLADES

|                    | HUMIDIFIER                |               |
|--------------------|---------------------------|---------------|
| PLAN DESIGNA       | ATION                     | H-1           |
| MANUFACTURE        | R                         | DRI-STEEM     |
| MODEL              |                           | ULTRA-SORB LH |
| TYPE               |                           | STEAM         |
| SERVICE            |                           | AHU-147       |
| AIR                | FLOW RATE - CFM           | 1,200         |
|                    | ENTERING DB TEMP - °F     | 55.0          |
|                    | ENTERING RH%              | 20.0          |
|                    | LEAVING DB TEMP - °F      | 55.0          |
| ROOM               | ROOM TEMP - °F            | 72.0          |
| CONDITIONS         | LEAVING RH %              | 35.0          |
| STEAM              | FLOW RATE - LBS/HR        | 39.0          |
|                    | STEAM PRESSURE - PSI      | 5.0           |
| NUMBER SIZE -      | - IN                      | 3             |
| STRAINER SIZE      | - IN                      | 3/4           |
| INLET - NPT        |                           | 1/2           |
| CONTROL            |                           | ELECTRONIC    |
| ABSORTION DI       | STANCE (VAPOR TRAIL)      | 14"           |
| FACE DIMENSI       | ONS (WxH) IN              | 24x 18        |
| 1. SELECTIONS BASE | D ON DRI-STEEM HUMIDIFIER |               |

| 1. SELECTIONS BASED ON DRI-STEEM HUMIDIFIER |
|---|
| 2. PROVIDE TEMPERATURE SWITCH               |
| 3. STEAM PRESSURE AT VALVE IS 4.0 PSI       |
|   |

NA=NOT APPLICABLE

| PLAN DESIGNAT | TON                 | RF-147      |
|---------------|---------------------|-------------|
| MANUFACTURE   | ₹                   | GREENHEC    |
| MODEL         |                     | G-095-VG    |
| FAN TYPE      |                     | ROOF MOUNT  |
| SERVES        |                     | PHARMACY CA |
| LOCATION      |                     | ROOF        |
| FAN           | CFM                 | 430         |
|               | ESP (IN.W.C.)       | 0.8         |
|               | DRIVE               | DIRECT      |
|               | MAX RPM             | 1,725       |
|               | NOM. FAN MOTOR (HP) | 1/6         |
|               | VOLTAGE/PHASE       | 115 / 1     |
| CABINET       | SIZE (DIAxH) IN     | 21.8x14.6   |
|               | WEIGHT (LBS)        | 60          |
| SOUND POWER   | 1ST OCTAVE          | 82          |
| MAX VALUES    | 2ND OCTAVE          | 80          |
| (INTAKE)      | 3RD OCATVE          | 73          |
|               | 4TH OCTAVE          | 67          |
|               | 5TH OCTAVE          | 64          |
|               | 6TH OCTAVE          | 59          |
|               | 7TH OCTAVE          | 50          |
|               | 8TH OCTAVE          | 47          |
|               | SONES               | 10.7        |
| REMARKS       |                     | 1 THRU 4    |

3. PROVIDE WITH ROOF CURB

4. PROVIDE WITH VARIGREEN SPEED CONTROLLER

WEIGHT - LBS 1. PROVIDE WITH HOT GAS REHEAT COIL

PLAN DESIGNATION MANUFACTURER

MODEL

LOCATION

MOUNTING

HEATING

LEAVING AIR TEMP - °F PRESSURE - LBS CONDENSATE - LBS/HR 72.4 COOLING TOTAL CAPACITY - MBH SENSIBLE CAPACITY - MBH ENTERING AIR TEMP - °F DB 82.2 ENTERING AIR TEMP - °F WB LEAVING AIR TEMP - °F DB LEAVING AIR TEMP - °F WB ESP - IN 1.05 1,750 208/3 CABINET SIZE (H x W x D) 45x44x82.5 850 1,2,3,4

**AIR HANDLING UNIT** 

SUPPLY - CFM

OUTSIDE AIR - CFM

ENTERING AIR TEMP - °F

CAPACITY - MBH

PHARMACY CACHE

ROOF

430

66.7


2. PROVIDE WITH DX COOLING COIL

3. PROVIDE WITH VARIABLE CAPACITY COMPRESSOR 4. PROVIDE WITH 2" & 4" PLEATED FILTERS

5. PROVIDE WITH 48" CURB WITH (2) ACCESS DOORS 6. SEE 23 81 00 FOR FURTHER FEATURES


### **VENTILATION SCHEDULE**

| BLDG | LEVEL  | ROOM           | ROOM USE  | AREA  | ACH REQ'D | ACH REQ'D   | CFM REQ'D | CFM REQ'D   | CFM REQ'D | ROOM AIR | CFM F  | PROVIDED    |
|------|--------|----------------|-----------|-------|-----------|-------------|-----------|-------------|-----------|----------|--------|-------------|
|      |        | NAME           |           | SQ FT | SUPPLY    | OUTSIDE AIR | SUPPLY    | OUTSIDE AIR | CALCS     | BALANCE  | SUPPLY | OUTSIDE AIR |
| 19 ( | GROUND | PHARMACY CACHE | WAREHOUSE | 1603  | 4         | 2           | 855       | 427         | 770       | NEUTRAL  | 1,200  | 430         |

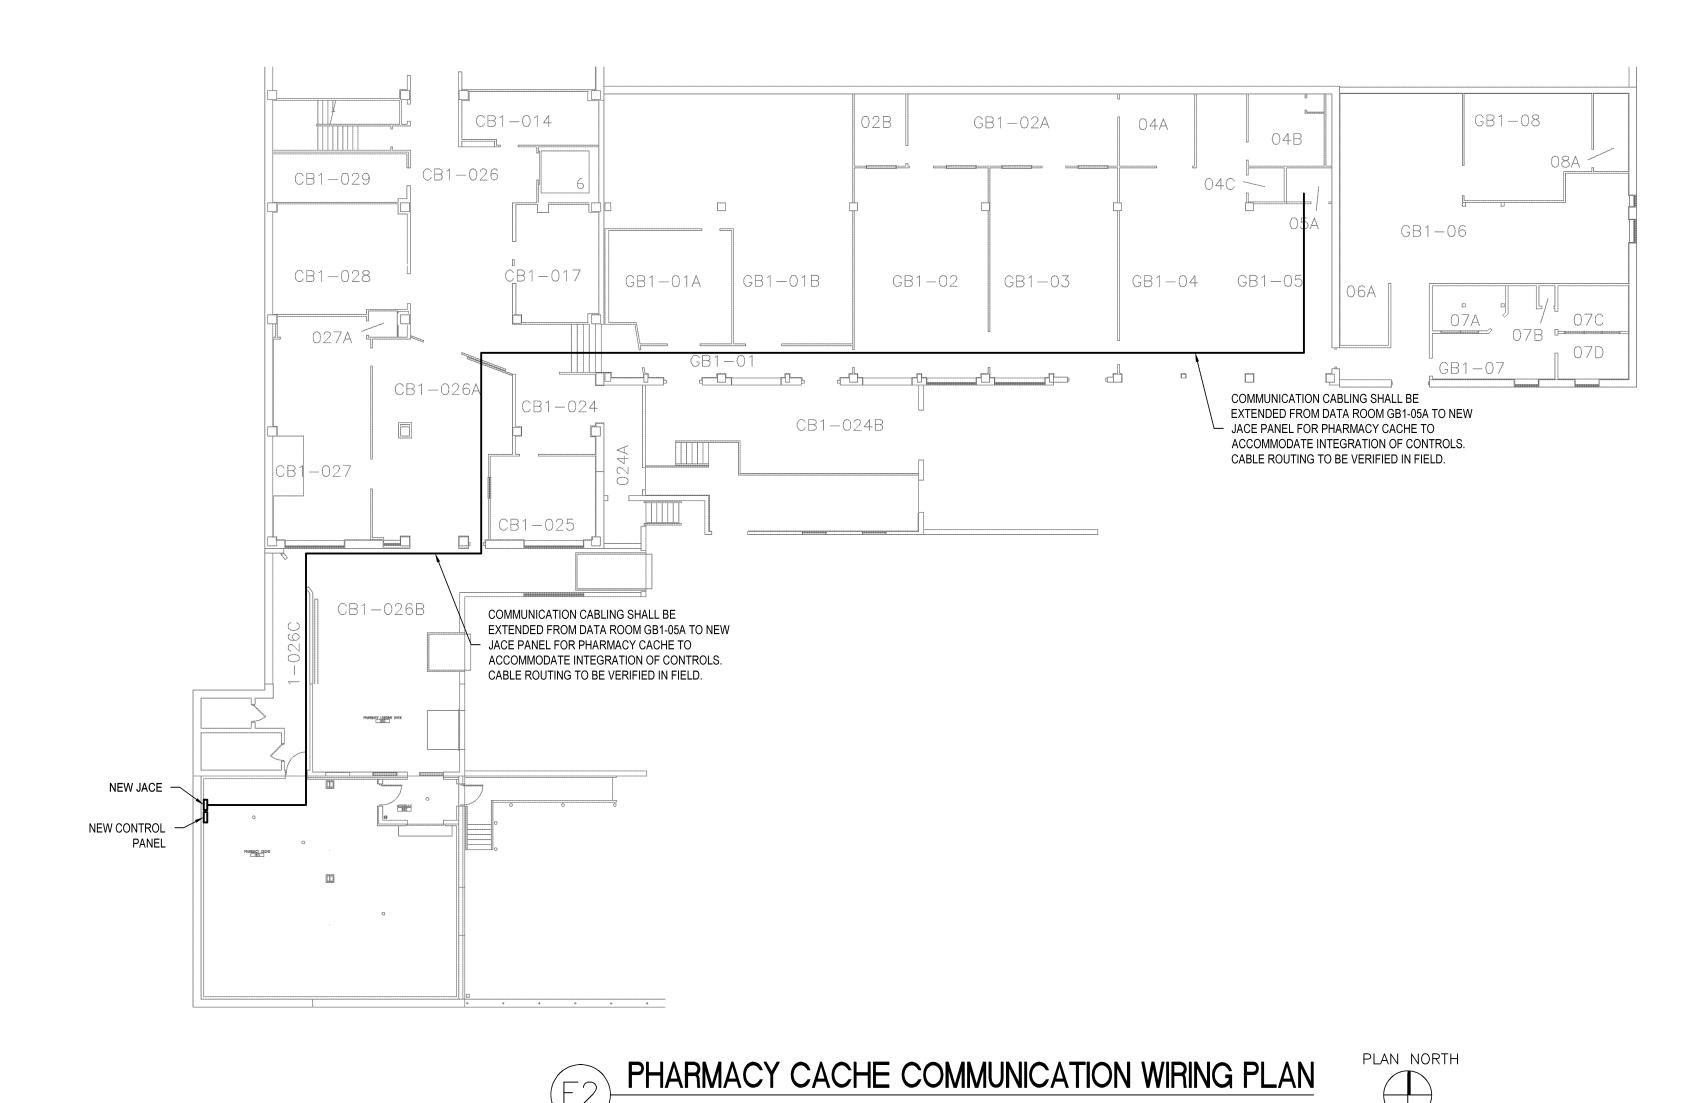

2 3 4 5

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3 INSTALL COOLING COIL CONDENSATE WASTE FROM ROOFTOP UNIT PER MANUFACTURER'S RECOMMENDATION. DISCHARGE CONDENSATE WASTE ONTO ROOF AND PROVIDE SPLASH BLOCK.

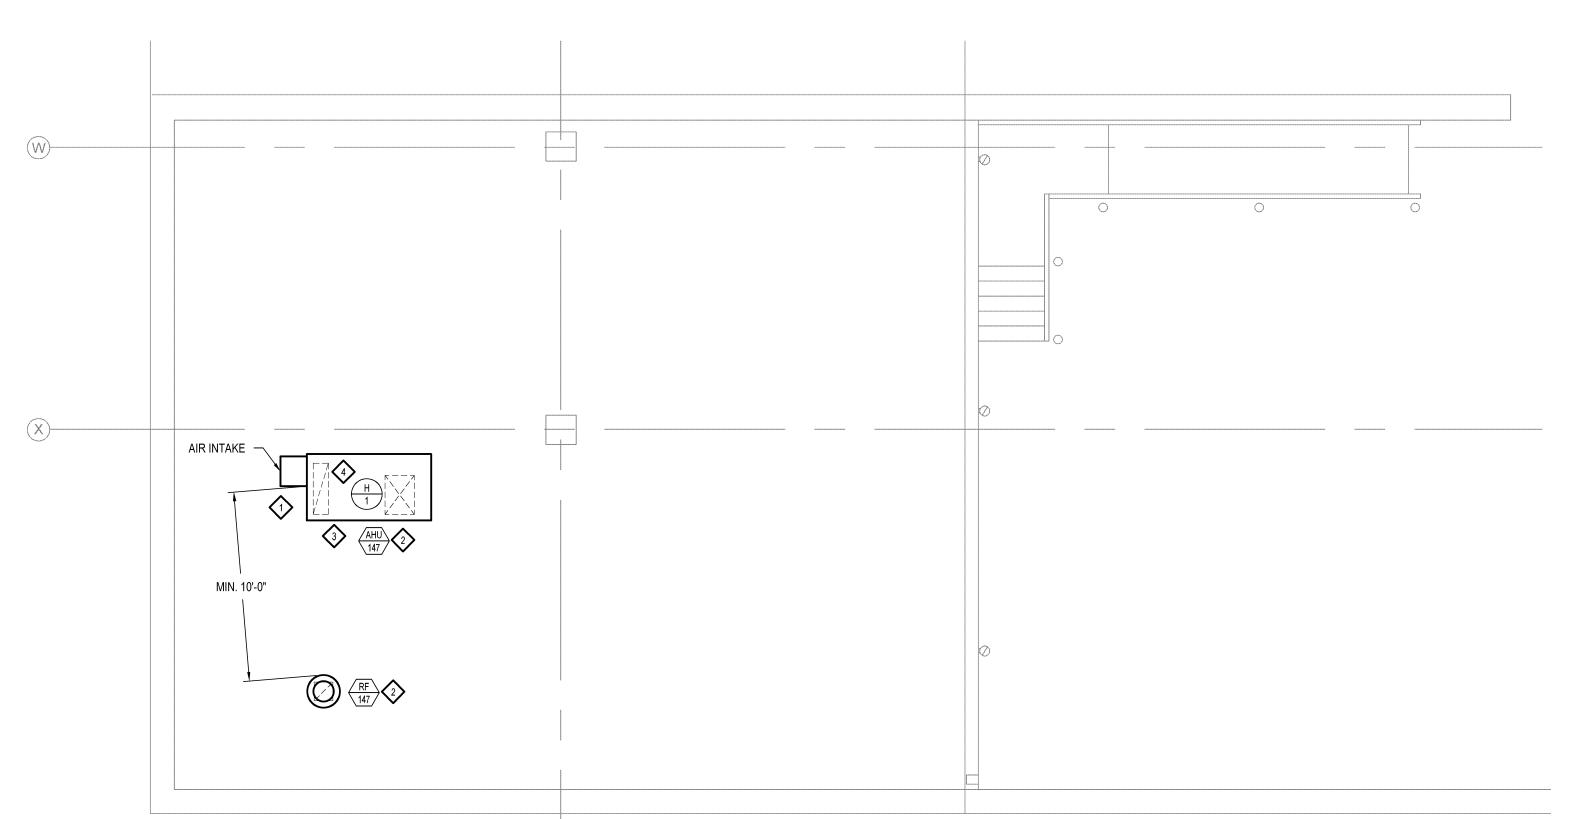**KEY NOTES** 

4 REFER TO DETAIL 1 ON SHEET M-200 FOR STEAM COIL AND HUMIDIFIER CONNECTIONS.

OUTSIDE AIR INTAKE HOOD FOR ROOFTOP UNIT SHALL BE MIN. 10 FT AWAY FROM EXHAUST FAN.

FIELD VERIFY EXACT LOCATION OF ALL NEW EQUIPMENT ON ROOF WITH STRUCTURAL BEAMS.

PHARMACY CACHE MECHANICAL ROOF PLAN


3/16" = 1'-0"


# 100% CONSTRUCTION DOCUMENTS


Project Title

Middleton VAH Drawing Title

MECHANICAL SCHEDULES, CONSULTANTS: ARCHITECT/ENGINEERS: Office of 607-13-101 Construct Pharmacy Cache ROOF PLAN AND COMMUNICATIONS Construction Building Number WIRING PLAN and Facilities Approved: Project Director Drawing Number Management Madison, WI p 262.641.0746 f 888.600.6207 architects M002 Checked Department of Veterans Affairs N8 W22195 JOHNSON DR, STE 180 262.549.1190 WAUKESHA, WI 53186 fx 262.549.1620 CDW TJK

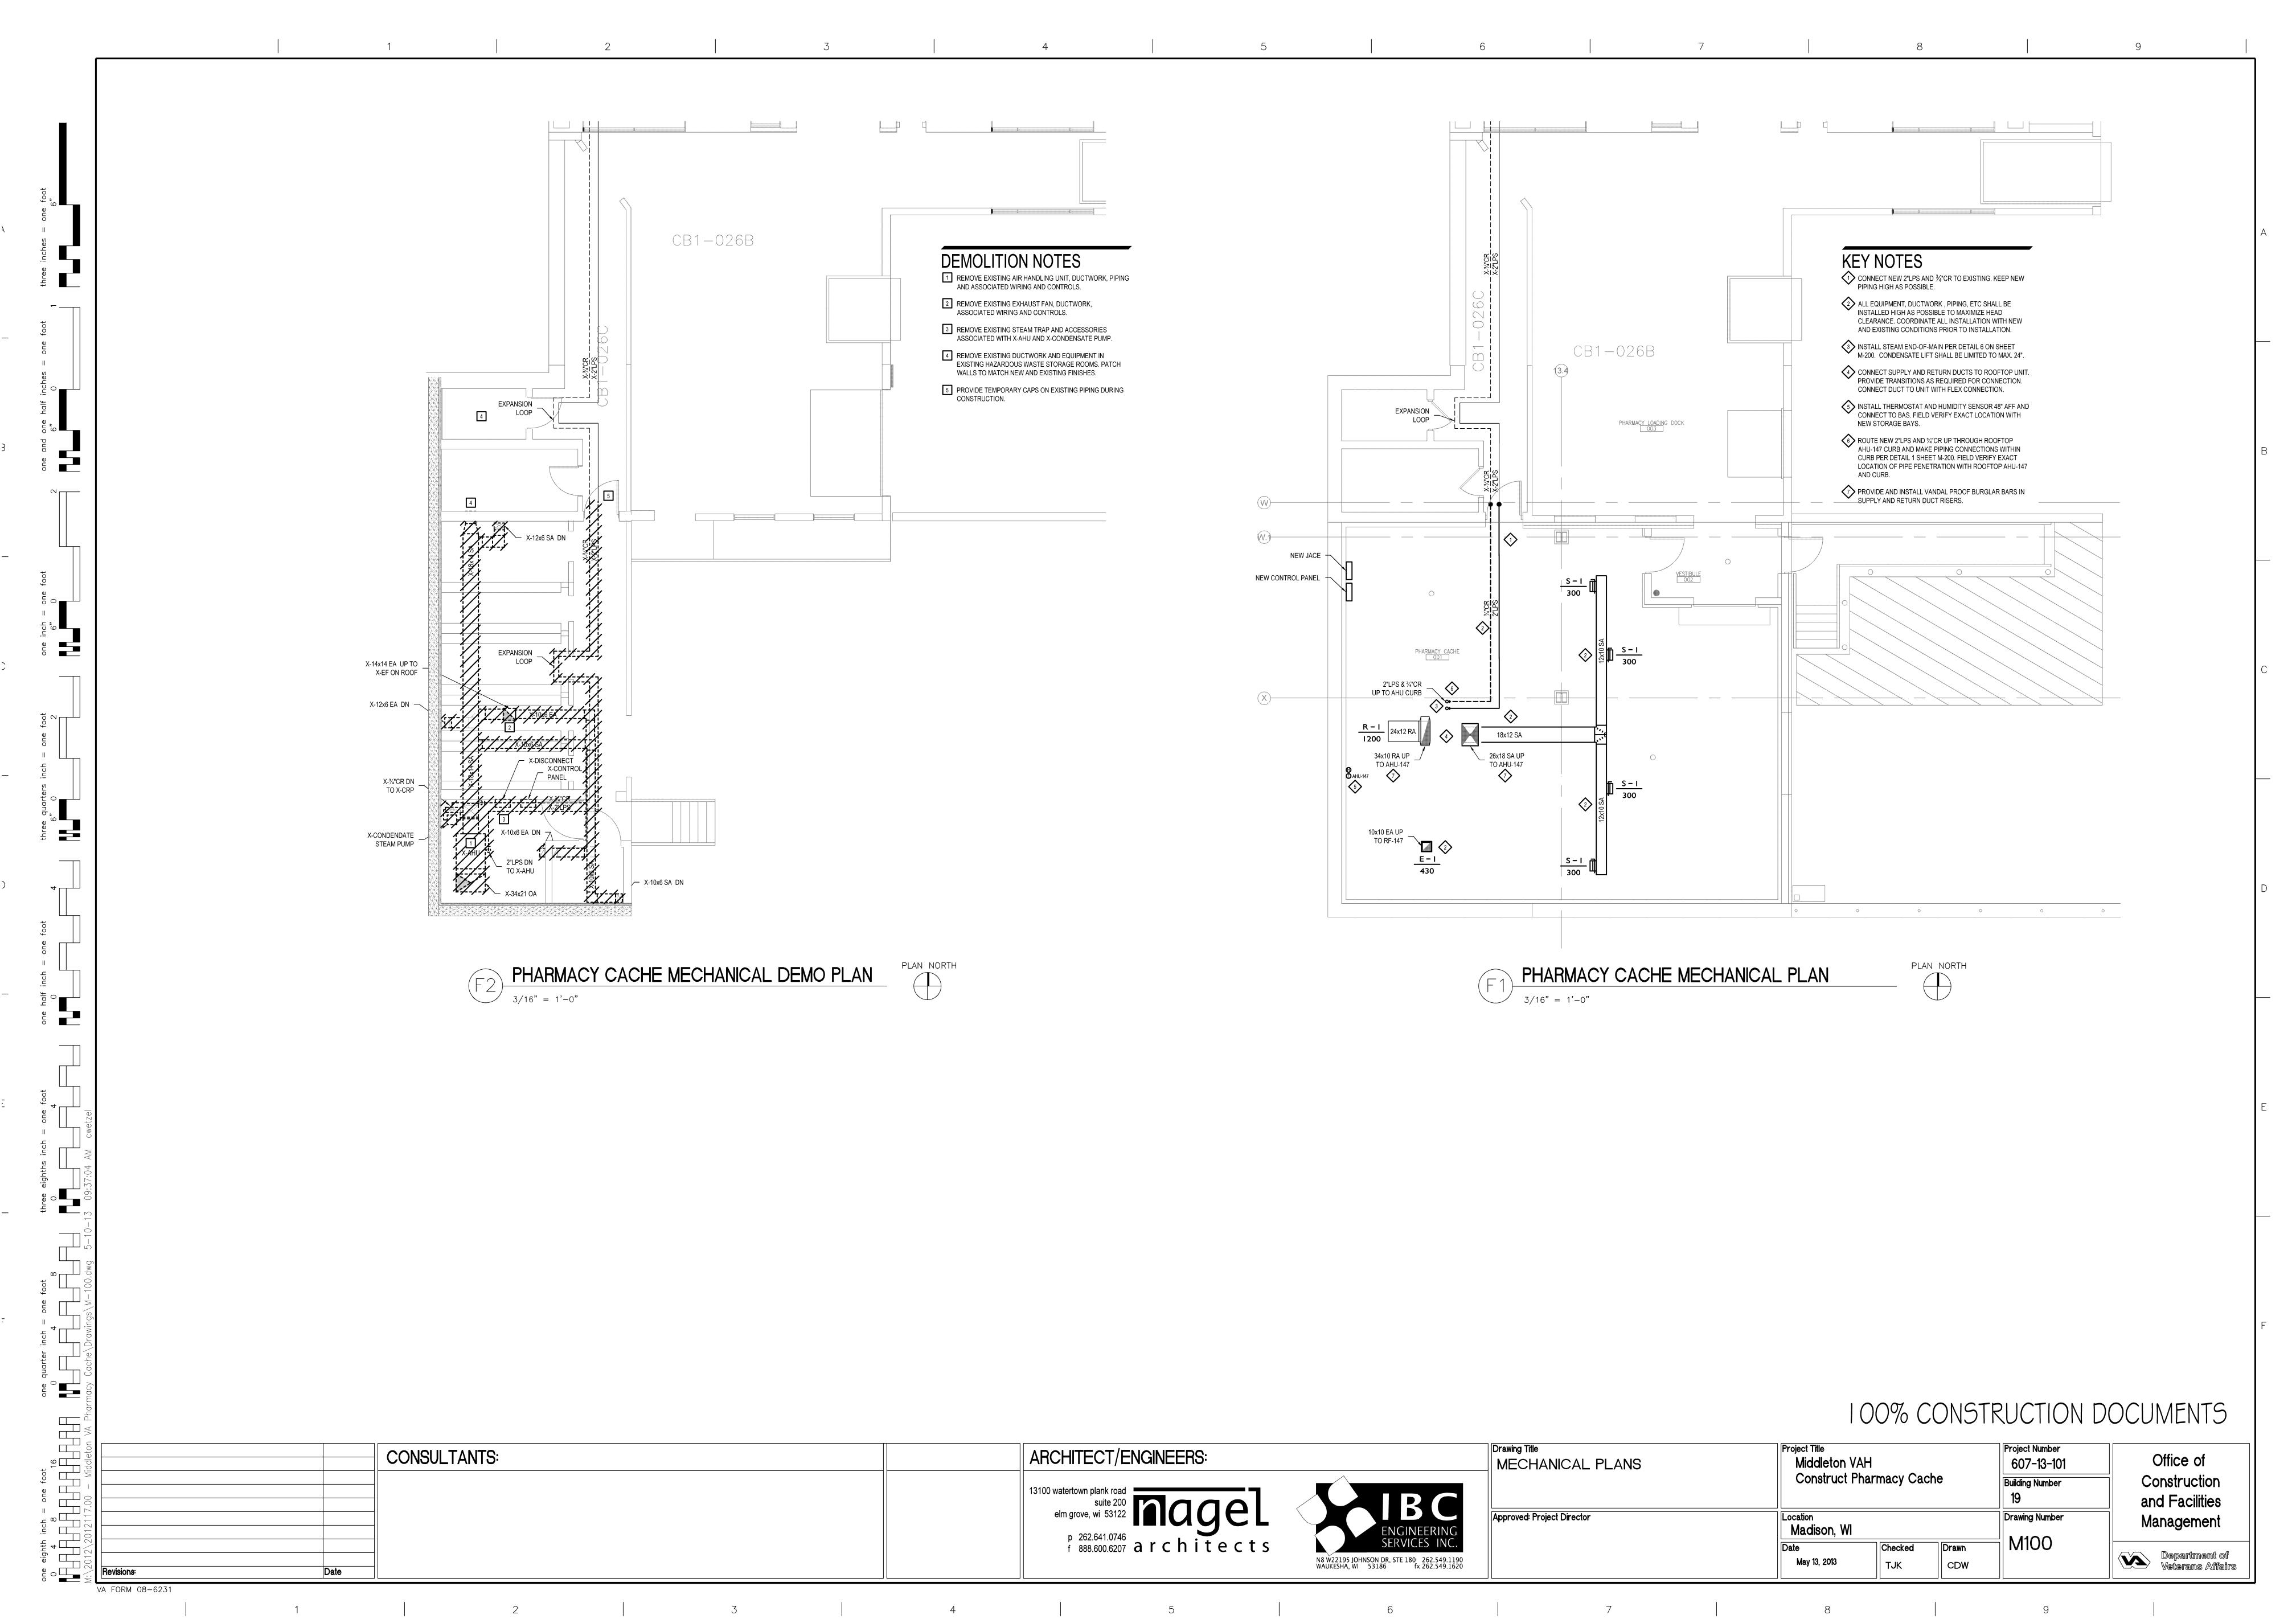

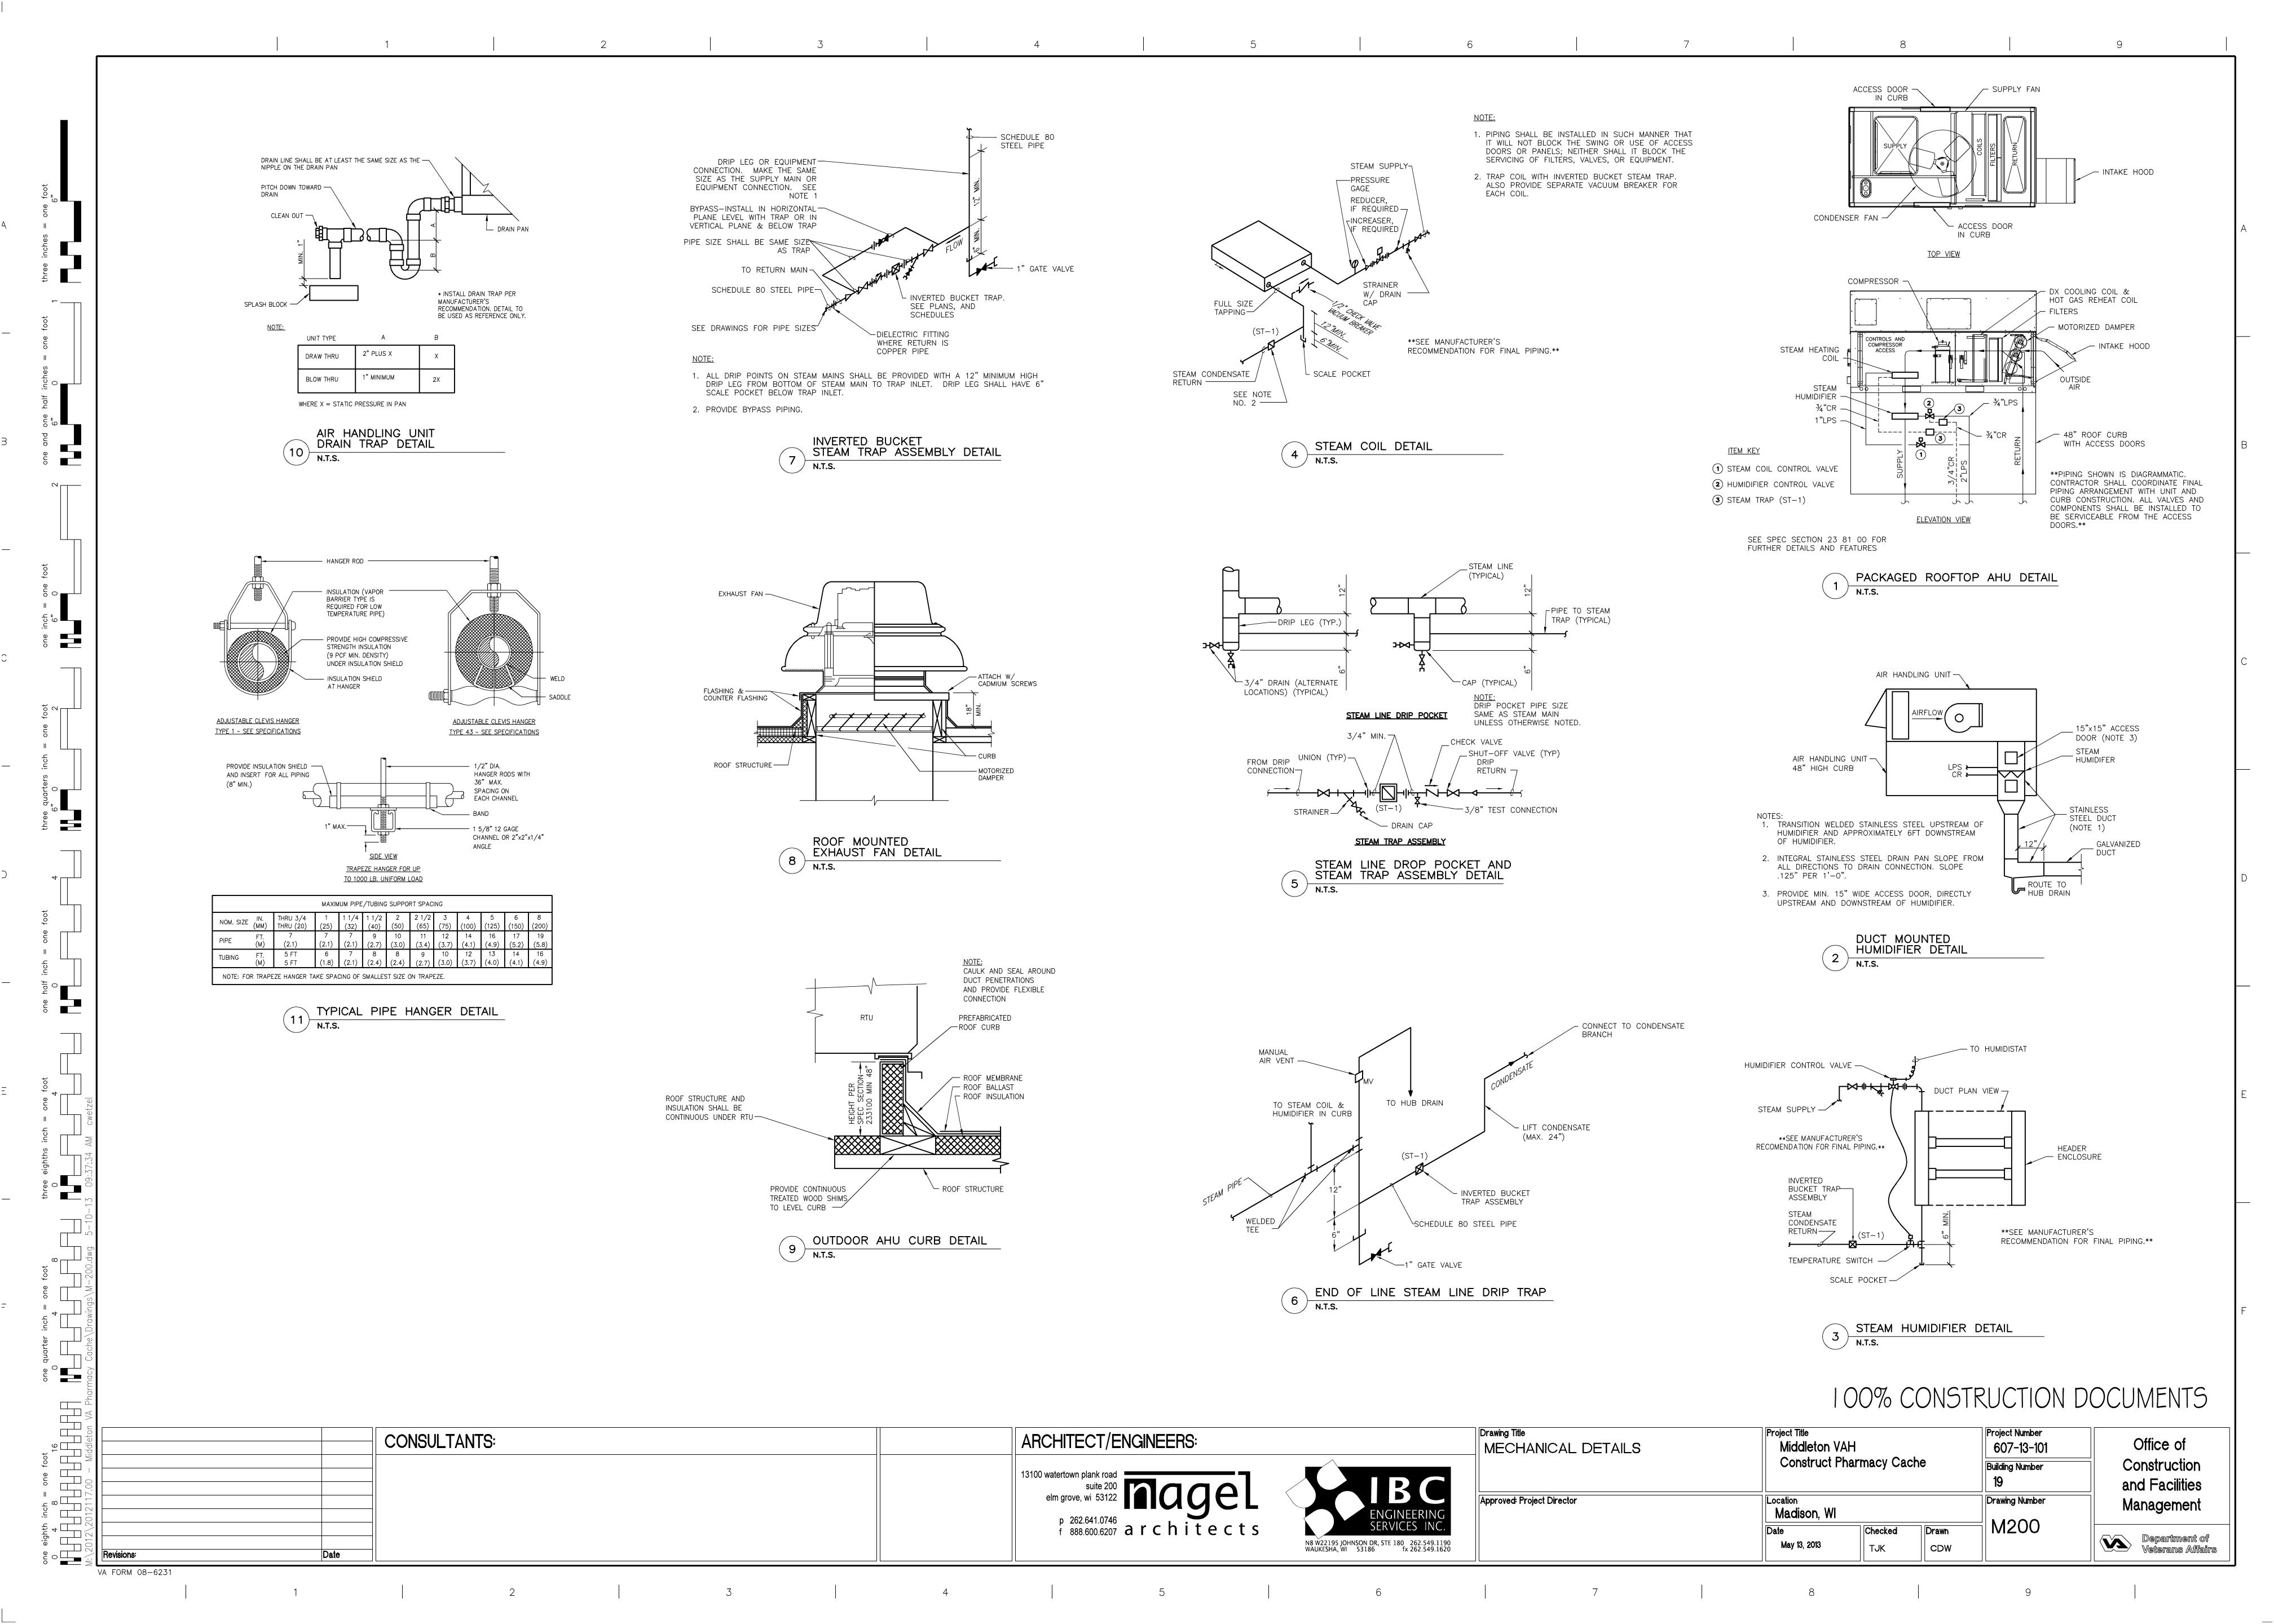

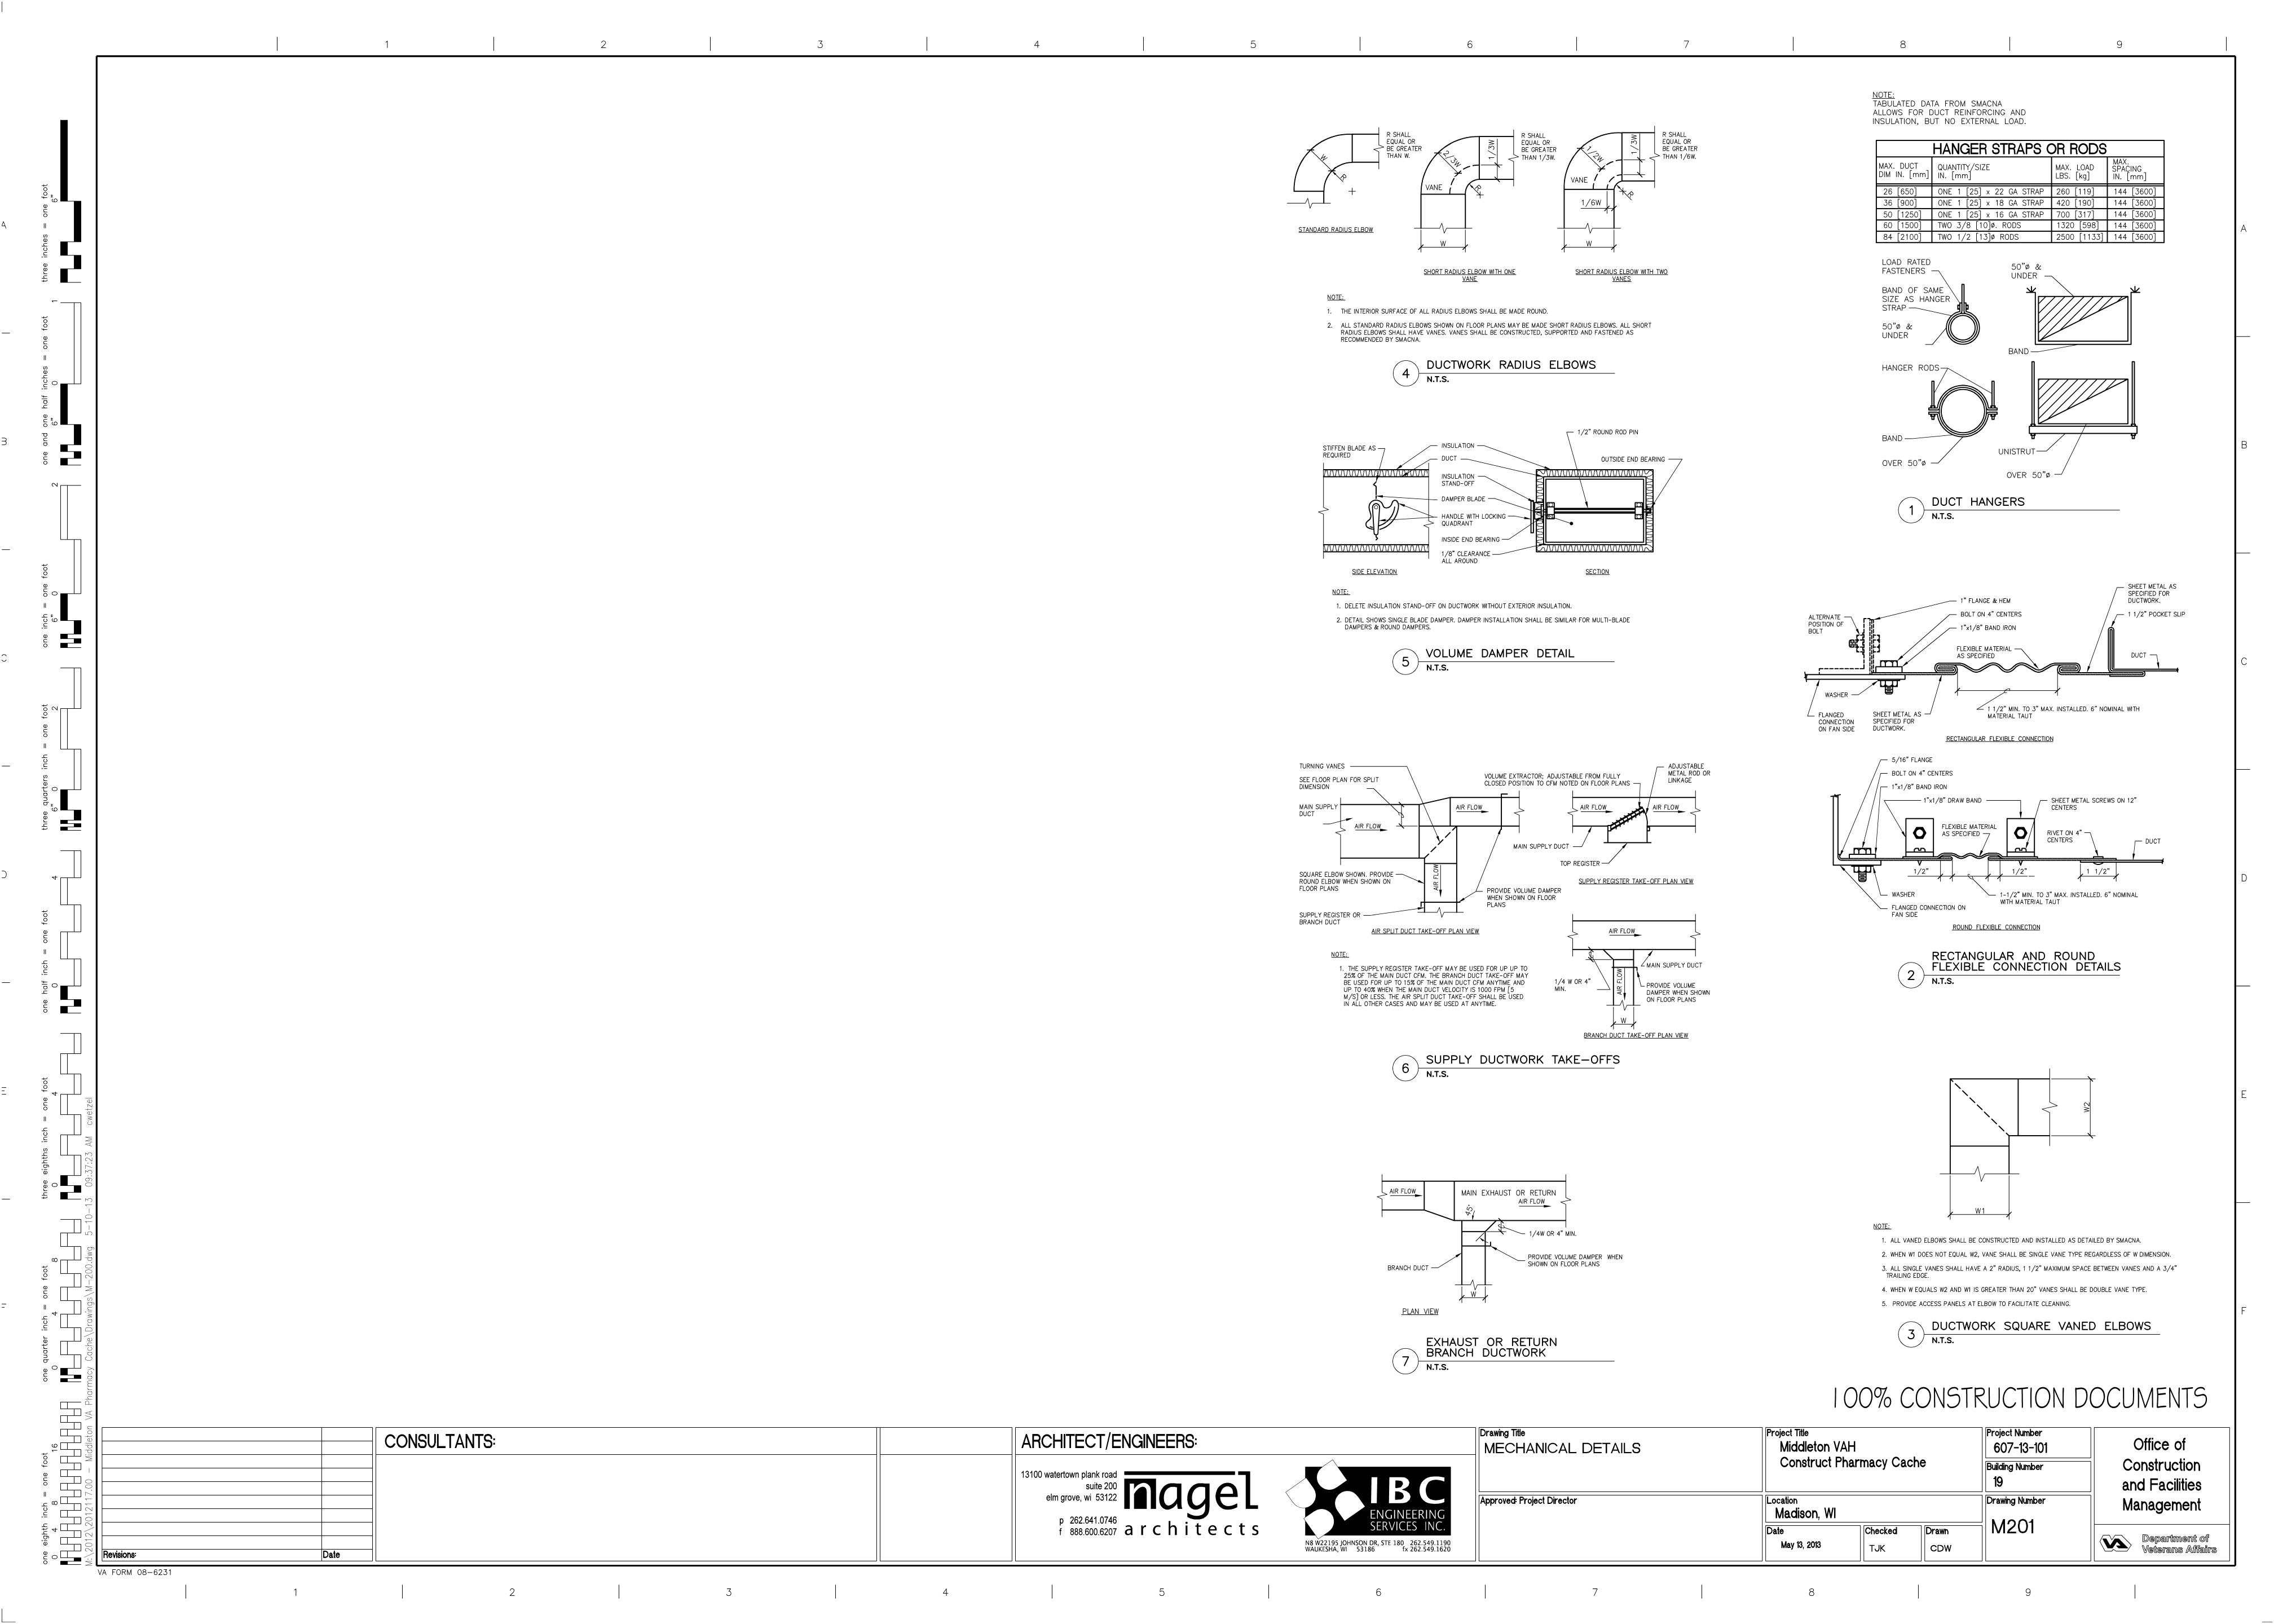



### NON-FUSED DISCONNECT SECURITY ELECTRIC STRIKE FUSED DISCONNECT SECURITY MAG LOCK MAGNETIC STARTER SECURITY DOOR CONTACTOR COMBINATION STARTER SECURITY CAMERA MOTOR SECURITY PAN, TILT, ZOOM CAMERA FIRE ALARM PULL STATION CARD ACCESS READER; LETTER INDICATES AS FOLLOWS: <u>M=MOUNT</u> C-CEILING D-DESK F-FLUSH H-HIDDEN FIRE ALARM SPEAKER STROBE M-MULLION P-PEDESTAL FIRE ALARM HEAT DETECTOR S-SURFACE W-WALL T=TECHNOLOGY/TYPE B-BARCODE F-ELEV. FLOOR CALL H-ELEV. HALL CALL M-MAG STRIP P-PROXIMITY S-SMART CARD T-TOKEN FIRE ALARM SMOKE DETECTOR FIRE ALARM DUCT DETECTOR MOTION DETECTOR; LETTER INDICATES AS FOLLOWS: M=MOUNT C-CEILING D-DESK F-FLUSH H-HIDDEN FIRE ALARM CONTROL MODULE M-MULLION P-PEDESTAL R-RACK S-SURFACE W-WALL FIRE ALARM MONITOR MODULE T=TECHNOLOGY/TYPE D-DUAL TECHNOLOGY IR-INFRARED M-MICROWAVE FIRE ALARM FLOW SWITCH U-ULTRASONIC X-REQUEST-FOR-EXIT FIRE ALARM TAMPER SWITCH PUSH BUTTON; LETTER INDICATES AS FOLLOWS: M=MOUNT C-CEILING D-DESK F-FLUSH H-HIDDEN WALL MOUNTED SPEAKER M-MULLION P-PEDESTAL S-SURFACE W-WALL T=TECHNOLOGY/TYPE B-BELL PUSH D-DURESS P-PANIC R-DOOR RELEASE X-REQUEST-FOR-EXIT

| 4W FOUR WIRE MLO MAIN LUG ONLY MTD MOUNTED  A AMPERE MTG MOUNTING  AFF ABOVE FINISHED FLOOR  AHJ AUTHORITY HAVING JURISDICTION NAC NOTIFICATION APPLIANCE CIRCUI NEC NATIONAL ELECTRICAL CODE NESS NON-FUSED SAFETY SWITCH NEC NATIONAL ELECTRICAL CODE NESS NON-FUSED SAFETY SWITCH NU NEAR UNIT  BLDG BUILDING OS OCCUPANCY SENSOR OU ON UNIT  C CONDUIT PP POLE CAT CATALOG PC PLUMBING CONTRACTOR PC PLUMBING CONTRACTOR PH PHASE CD CANDELA PNL PANEL CKT CIRCUIT PVC POLYVINYL CHLORIDE (PLASTIC) CLG CEILING PW PRE-WIRED CP CONTROL PANEL PWR POWER  CS COMBINATION STARTER  CU COPPER RECPT RECEPTACLE RM ROOM REQ'D REQUIRED  DEMO DEMOLITION REQ'D REQUIRED   | ELEC                                     | TRICAL ABBREVIAT   | IONS  |  |
|--|--|--|---|--|
| AFF ABOVE FINISHED FLOOR AHJ AUTHORITY HAVING JURISDICTION AIC AMPERE INTERRUPTING CAPACITY AMP AMPERE AUTO AUTOMATIC  BLDG BUILDING BREAKER  C CONDUIT CAT CATALOG C CENCUIT BREAKER C C CANDELA C CIRCUIT BREAKER C C COMBINATION STARTER C C CELICIC CELIC COMBINATION STARTER C C COMBINATION STARTER C C COMBINATION STARTER C C C COMBINATION STARTER C C C C C C C C C C C C C C C C C C C  | 1PH<br>2P<br>2W<br>3P<br>3PH<br>3W<br>4W | SINGLE PHASE TWO POLE TWO WIRE THREE POLE THREE PHASE THREE WIRE FOUR WIRE             | MAN<br>MC<br>MCA<br>MIN<br>MOCP<br>MLO<br>MTD | MANUAL STARTER MAXIMUM MECHANICAL CONTRACTOR MINIMUM CIRCUIT AMPACITY MINIMUM MAXIMUM OVERCURRENT PROTECTION MAIN LUG ONLY MOUNTED |
| BKR BREAKER OU ON UNIT  C CONDUIT CAT CATALOG CB CIRCUIT BREAKER CD CANDELA CKT CIRCUIT CKT CIRCUIT CC COMUNIT CC CIRCUIT BREAKER CD CANDELA CKT CIRCUIT CC CIRCUIT CC CILING CC CILING CC COMINATION STARTER CC COMMINIATION STARTER CC COPPER CC COMMINIATION CC COPPER CC COMMINIT CC COPPER CC COMMINIATION CC COPPER CC COMMINITION CC COPPER CC COMMINITION CC COPPER CC COPPER CC COMMINITION CC COPPER CC COPPER CC COPPER CC COMMINITION CC COPPER CC COPPER CC COPPER CC COMMINITION CC COPPER CC COPPER CC COMMINITION CC COPPER CC COPPER CC COPPER CC COPPER CC COMMINITION CC COPPER CC CONTROLOR CC COPPER CC COPPER CC CONTROLOR CC COPPER CC CONTROLOR CC COPPER CC CONTROLOR CC COPPER CC COPPER CC CONTROLOR CC CONTROLOR CC COPPER CC CONTRO | AFF<br>AHJ<br>AIC<br>AMP                 | ABOVE FINISHED FLOOR AUTHORITY HAVING JURISDICTION AMPERE INTERRUPTING CAPACITY AMPERE | NAC<br>NEC<br>NFSS                            | NOTIFICATION APPLIANCE CIRCUIT<br>NATIONAL ELECTRICAL CODE<br>NON-FUSED SAFETY SWITCH  |
| CAT CATALOG CB CIRCUIT BREAKER CD CANDELA CKT CIRCUIT CC CANDELA CKT CIRCUIT CC CANDELA CKT CIRCUIT CC CEILING CP CONTROL PANEL CS COMBINATION STARTER CU COPPER CD COMBINATION COMBINATION CS COMBINATION CHACLE CSC COMBINATION CHACLE CANDEL CHACLE CONTROL CHACLE CSC CONTROL CHACLE CONTROL CHACLE CSC CONTROL CHACLE  |  |  |   |  |
| CU COPPER RECEPTACLE RM ROOM DEMOLITION DISC DISCONNECT DIST DISTRIBUTION DOWN SF SQUARE FOOT (FEET)  EBU EMERGENCY BATTERY UNIT EC ELECTRICAL CONTRACTOR EMER EMERGENCY EMET ELECTRICAL METALLIC TUBING ES ELECTRIC STRIKE ES ELECTRIC STRIKE ETR EXISTING TO BE RELOCATED ETR EXISTING TO REMAIN  FACP FIRE ALARM CONTROL PANEL FLA FULL LOAD AMPERE FSS FUSED SAFETY SWITCH  GC GENERAL CONTRACTOR GFI / GFCI GROUND FAULT CIRCUIT INTERRUPTER GND GROUND  MRECPT RECEPTACLE RM ROOM REQ'D REQUIRED  SD SMOKE DETECTOR OR SMOKE DA SW SWITCH  SW SWITCH  TYP TYPICAL  TYP TYPICAL  VOLT VOLT  VYOLT  VAIABLE FREQUENCY DRIVE  WATT OR WIRE WEATHERPROOF  X- EXISTING GC GENERAL CONTRACTOR STAMPER  WEATHERPROOF  X- EXISTING TRANSFORMER  MRECPTACLE RM ROOM REQ'D REQUIRED  SMOKE DETECTOR OR SMOKE DA SWITCH  WATTOR WEATHERPROOF  X- EXISTING TRANSFORMER  MRECPTACLE RM ROOM SPEQUIRED  SMOKE DETECTOR OR SMOKE DA SWITCH  WASHING WATTOR WIRE WEATHERPROOF  X- EXISTING TRANSFORMER  MRECPTACLE RM ROOM SPEQUIRED  SMOKE DETECTOR OR SMOKE DA SWUTCH  WATTOR WEATHER TRANSFORMER  TRANSFORMER  MRECP'D TRANSFORMER  TRANSFORMER  MRECP'D TRANSFORMER  TRANSFORMER  MRECP'D TRANSFORMER  TRANSFORMER  MRECP'D TRANSFORMER  TRANSFORMER  TRANSFORMER  MRECP'D TRANSFORMER  TRANSFORMER  MRECP'D TRANSFORMER  TRANSFORMER  TRANSFORMER  TRANSFORMER  TRANSFORMER  TRANSFORMER  TRANSFORMER  TRANSFORMER  TRANSFORMER   | CAT<br>CB<br>CD<br>CKT<br>CLG<br>CP      | CATALOG CIRCUIT BREAKER CANDELA CIRCUIT CEILING CONTROL PANEL                          | PC<br>PH<br>PNL<br>PVC<br>PW                  | PLUMBING CONTRACTOR PHASE PANEL POLYVINYL CHLORIDE (PLASTIC) PRE-WIRED   |
| DIST DISTRIBUTION DOWN SF SQUARE FOOT (FEET) SW SWITCH  EBU EMERGENCY BATTERY UNIT EC ELECTRICAL CONTRACTOR EMER EMERGENCY EMT ELECTRICAL METALLIC TUBING ERL EXISTING TO BE RELOCATED ES ELECTRIC STRIKE ETR EXISTING TO REMAIN  FACP FIRE ALARM CONTROL PANEL FLA FULL LOAD AMPERE FSS FUSED SAFETY SWITCH  GC GENERAL CONTRACTOR GFI / GFCI GROUND FAULT CIRCUIT INTERRUPTER GND GROUND  HP HORSE POWER  IMC INTERMEDIATE METALLIC CONDUIT IIU IN UNIT  K KEY OPERATED  | CU<br>DEMO                               | COPPER DEMOLITION  | RM  | ROOM   |
| EBU EMERGENCY BATTERY UNIT EC ELECTRICAL CONTRACTOR EMER EMERGENCY EMT ELECTRICAL METALLIC TUBING ERL EXISTING TO BE RELOCATED ES ELECTRIC STRIKE ETR EXISTING TO REMAIN  FACP FIRE ALARM CONTROL PANEL FAS FUSED SAFETY SWITCH  GC GENERAL CONTRACTOR GFI / GFCI GROUND FAULT CIRCUIT INTERRUPTER GND GROUND  HP HORSE POWER  IMC INTERMEDIATE METALLIC CONDUIT IU IN UNIT  K KEY OPERATED  | DIST                                     | DISTRIBUTION   | SF  |  |
| FACP FIRE ALARM CONTROL PANEL FLA FULL LOAD AMPERE FSS FUSED SAFETY SWITCH  GC GENERAL CONTRACTOR GFI / GFCI GROUND FAULT CIRCUIT INTERRUPTER GND GROUND  HP HORSE POWER  IMC INTERMEDIATE METALLIC CONDUIT IU IN UNIT  K KEY OPERATED   | EC<br>EMER<br>EMT<br>ERL                 | ELECTRICAL CONTRACTOR EMERGENCY ELECTRICAL METALLIC TUBING EXISTING TO BE RELOCATED    | TYP<br>V<br>VA                                | TYPICAL<br>VOLT<br>VOLT AMPERE   |
| GC GENERAL CONTRACTOR XFMR TRANSFORMER  GFI / GFCI GROUND FAULT CIRCUIT INTERRUPTER  GND GROUND  HP HORSE POWER  IMC INTERMEDIATE METALLIC CONDUIT  IU IN UNIT  K KEY OPERATED   | FACP<br>FLA                              | FIRE ALARM CONTROL PANEL<br>FULL LOAD AMPERE   | WAP<br>WP                                     | WIRELESS ACCESS POINT<br>WEATHERPROOF  |
| IMC INTERMEDIATE METALLIC CONDUIT IU IN UNIT  K KEY OPERATED   | GFI / GFCI                               | GROUND FAULT CIRCUIT INTERRUPTER   |   |  |
| IU IN UNIT  K KEY OPERATED   | HP                                       | HORSE POWER  |   |  |
|  |  |  |   |  |
|  |  |  |   |  |
| LED LIGHT EMITTING DIODE<br>LF LINEAR FOOT (FEET)<br>LTG LIGHTING  | LF                                       | LINEAR FOOT (FEET)   |   |  |

- 1. ALL WORK SHALL COMPLY WITH APPLICABLE NATIONAL, STATE, LOCAL CODES, FEDERAL AND STATE REGULATIONS, AND ALL REQUIREMENTS OF THE LOCAL AUTHORITIES HAVING JURISDICTION.
- 2. THE CONTRACTOR SHALL VISIT THE SITE TO DETERMINE THE FULL EXTENT OF WORK, AND PROJECT CONDITIONS, AND SHALL BE FAMILIAR WITH THE LOCAL CONDITIONS AND CODES RELATING TO THE WORK. FAILURE TO DO SO WILL NOT RELIEVE THE CONTRACTOR OF THE OBLIGATIONS OF THE CONTRACT.
- 3. THE CONTRACTOR SHALL NOTIFY THE ARCHITECT AND ENGINEER IN WRITING OF ANY EQUIPMENT, MATERIALS, INSTALLATIONS, ETC., THAT ARE DEFICIENT OR IN VIOLATION OF LOCAL CODES AND REGULATIONS.
- 4. THE CONTRACTOR SHALL FURNISH AND INSTALL ALL MATERIAL, LABOR, EQUIPMENT, DEVICES, FIXTURES, SERVICE REQUIREMENTS, ETC., NECESSARY FOR A COMPLETE AND FULLY OPERATIONAL ELECTRICAL SYSTEM/INSTALLATION.
- 5. THE CONTRACTOR SHALL PERFORM WORK IN ACCORDANCE WITH THESE DRAWINGS. WHERE MORE STRINGENT REQUIREMENTS ARE SET FORTH BY THE ARCHITECTURAL DRAWINGS OR LOCAL CODES AND REGULATIONS, THE GREATER REQUIREMENTS SHALL GOVERN. ANY DEVIATIONS FROM THESE DRAWINGS SHALL BE RECORDED AND PROVIDED IN WRITING TO THE ARCHITECT AND ENGINEER.
- 6. THE ELECTRICAL DRAWINGS ARE DIAGRAMMATIC AND THE CONTRACTOR SHALL INSTALL EQUIPMENT TO MEET THE FIELD CONDITIONS WITH COORDINATION FROM APPROVED SHOP DRAWINGS.
- 7. THE CONTRACTOR SHALL COORDINATE ALL WORK WITH THE RESPECTIVE TRADES AND VERIFY LOCATIONS AND REQUIREMENTS FROM THE ARCHITECTURAL DRAWINGS, FIELD MEASUREMENTS AND SUPPLIER SHOP DRAWINGS.
- 8. THE CONTRACTOR SHALL CHECK ALL DRAWINGS AND SPECIFICATIONS OF OTHER TRADES AND INCLUDE IN THEIR BID ANY ADDITIONAL WORK REQUIRED BY THIS
- 9. REFER TO ARCHITECTURAL DRAWINGS FOR EXACT LOCATIONS AND MOUNTING HEIGHTS OF ALL LIGHT SWITCHES, POWER, AND COMMUNICATIONS OUTLETS. ALL OUTLETS SHALL BE MOUNTED VERTICALLY UNLESS OTHERWISE NOTED. COORDINATE ALL FINAL DEVICE REQUIREMENTS WITH ARCHITECT PRIOR TO INSTALLATION.
- 10. ALL CONDUITS SHOULD BE SUPPORTED IN COMPLIANCE WITH CODE REQUIREMENTS AND INSTALLED IN A MANNER AS TO AFFORD MINIMUM INTERFERENCE WITH OTHER TRADES. ALL CONDUITS ABOVE CEILING SHALL BE RIGIDLY SUPPORTED BY SUITABLE HANGERS FROM THE STRUCTURAL SLAB DECK OR FRAMING ABOVE INDEPENDENT OF THE CEILING, CEILING SUPPORT SYSTEM AND OTHER TRADE COMPONENTS. ALL CONDUITS SHALL BE CONCEALED UNLESS OTHERWISE NOTED ON DRAWINGS.
- 11. FIRE RATED SEALS SHALL BE PROVIDED FOR ALL CONDUIT PENETRATIONS THROUGH FIRE RATED FLOORS, WALLS, AND CEILINGS.
- 12. CONTRACTOR SHALL VERIFY ALL EQUIPMENT CONNECTION CONFIGURATIONS BEFORE PURCHASE. ALL DEVICES SHOWN ARE FOR REFERENCE ONLY, TO COMMUNICATE DESIGN INTENT, FINAL LOCATIONS SHALL BE VERIFIED PRIOR TO INSTALLATION. THIS NOTE SHALL APPLY TO, BUT NOT BE LIMITED TO, RECEPTACLES, SWITCHES, DATA PORTS, AUDIO/VIDEO DEVICES, AND TELEPHONE JACKS.
- 13. THE CONTRACTOR SHALL COORDINATE AND VERIFY ALL ABOVE CEILING REQUIREMENTS (PLENUM. NON-PLENUM, AIR HANDLING, ETC.) AS REQUIRED BY LOCAL AUTHORITY BEFORE THE INSTALLATION AND PURCHASE OF ELECTRICAL EQUIPMENT, MATERIALS AND DEVICES, WIRING, CABLING, AND THE ORDERING OF LIGHTING FIXTURES.
- 14. CONDUCTOR SIZES INDICATED ARE MINIMUM SIZES BASED ON 75°C COPPER CONDUCTOR. AMPACITIES OF CONDUCTORS DO NOT TAKE VOLTAGE DROP INTO CONSIDERATION. CONTRACTOR SHALL SIZE CONDUCTORS FOR FEEDERS AND BRANCH CIRCUITS TO PREVENT A VOLTAGE DROP EXCEEDING 3 PERCENT AT THE FARTHEST OUTLET OF POWER, HEATING, AND LIGHTING LOADS, OR COMBINATION OF SUCH LOADS, AND WHERE THE MAXIMUM TOTAL VOLTAGE DROP ON BOTH FEEDERS AND BRANCH CIRCUITS TO THE FARTHEST OUTLET DOES NOT EXCEED 5 PERCENT, TO PROVIDE REASONABLE EFFICIENCY OF OPERATION.

### SHEET INDEX

E000 : ELECTRICAL SYMBOLS AND ABBREVIATIONS E100 : ELECTRICAL PANEL LOCATION AND DEMOLITION PLANS E101: ELECTRICAL LIGHTING, POWER AND SYSTEMS PLANS E200: ELECTRICAL SCHEDULES

# 100% CONSTRUCTION DOCUMENTS

CONSULTANTS: ARCHITECT/ENGINEERS: p 262.641.0746 f 888.600.6207 architects

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VA FORM 08-623



Drawing Title

ELECTRICAL GENERAL NOTES, LEGENDS AND SCHEDULES Approved: Project Director

Project Title

Middleton VAH Construct Pharmacy Cache


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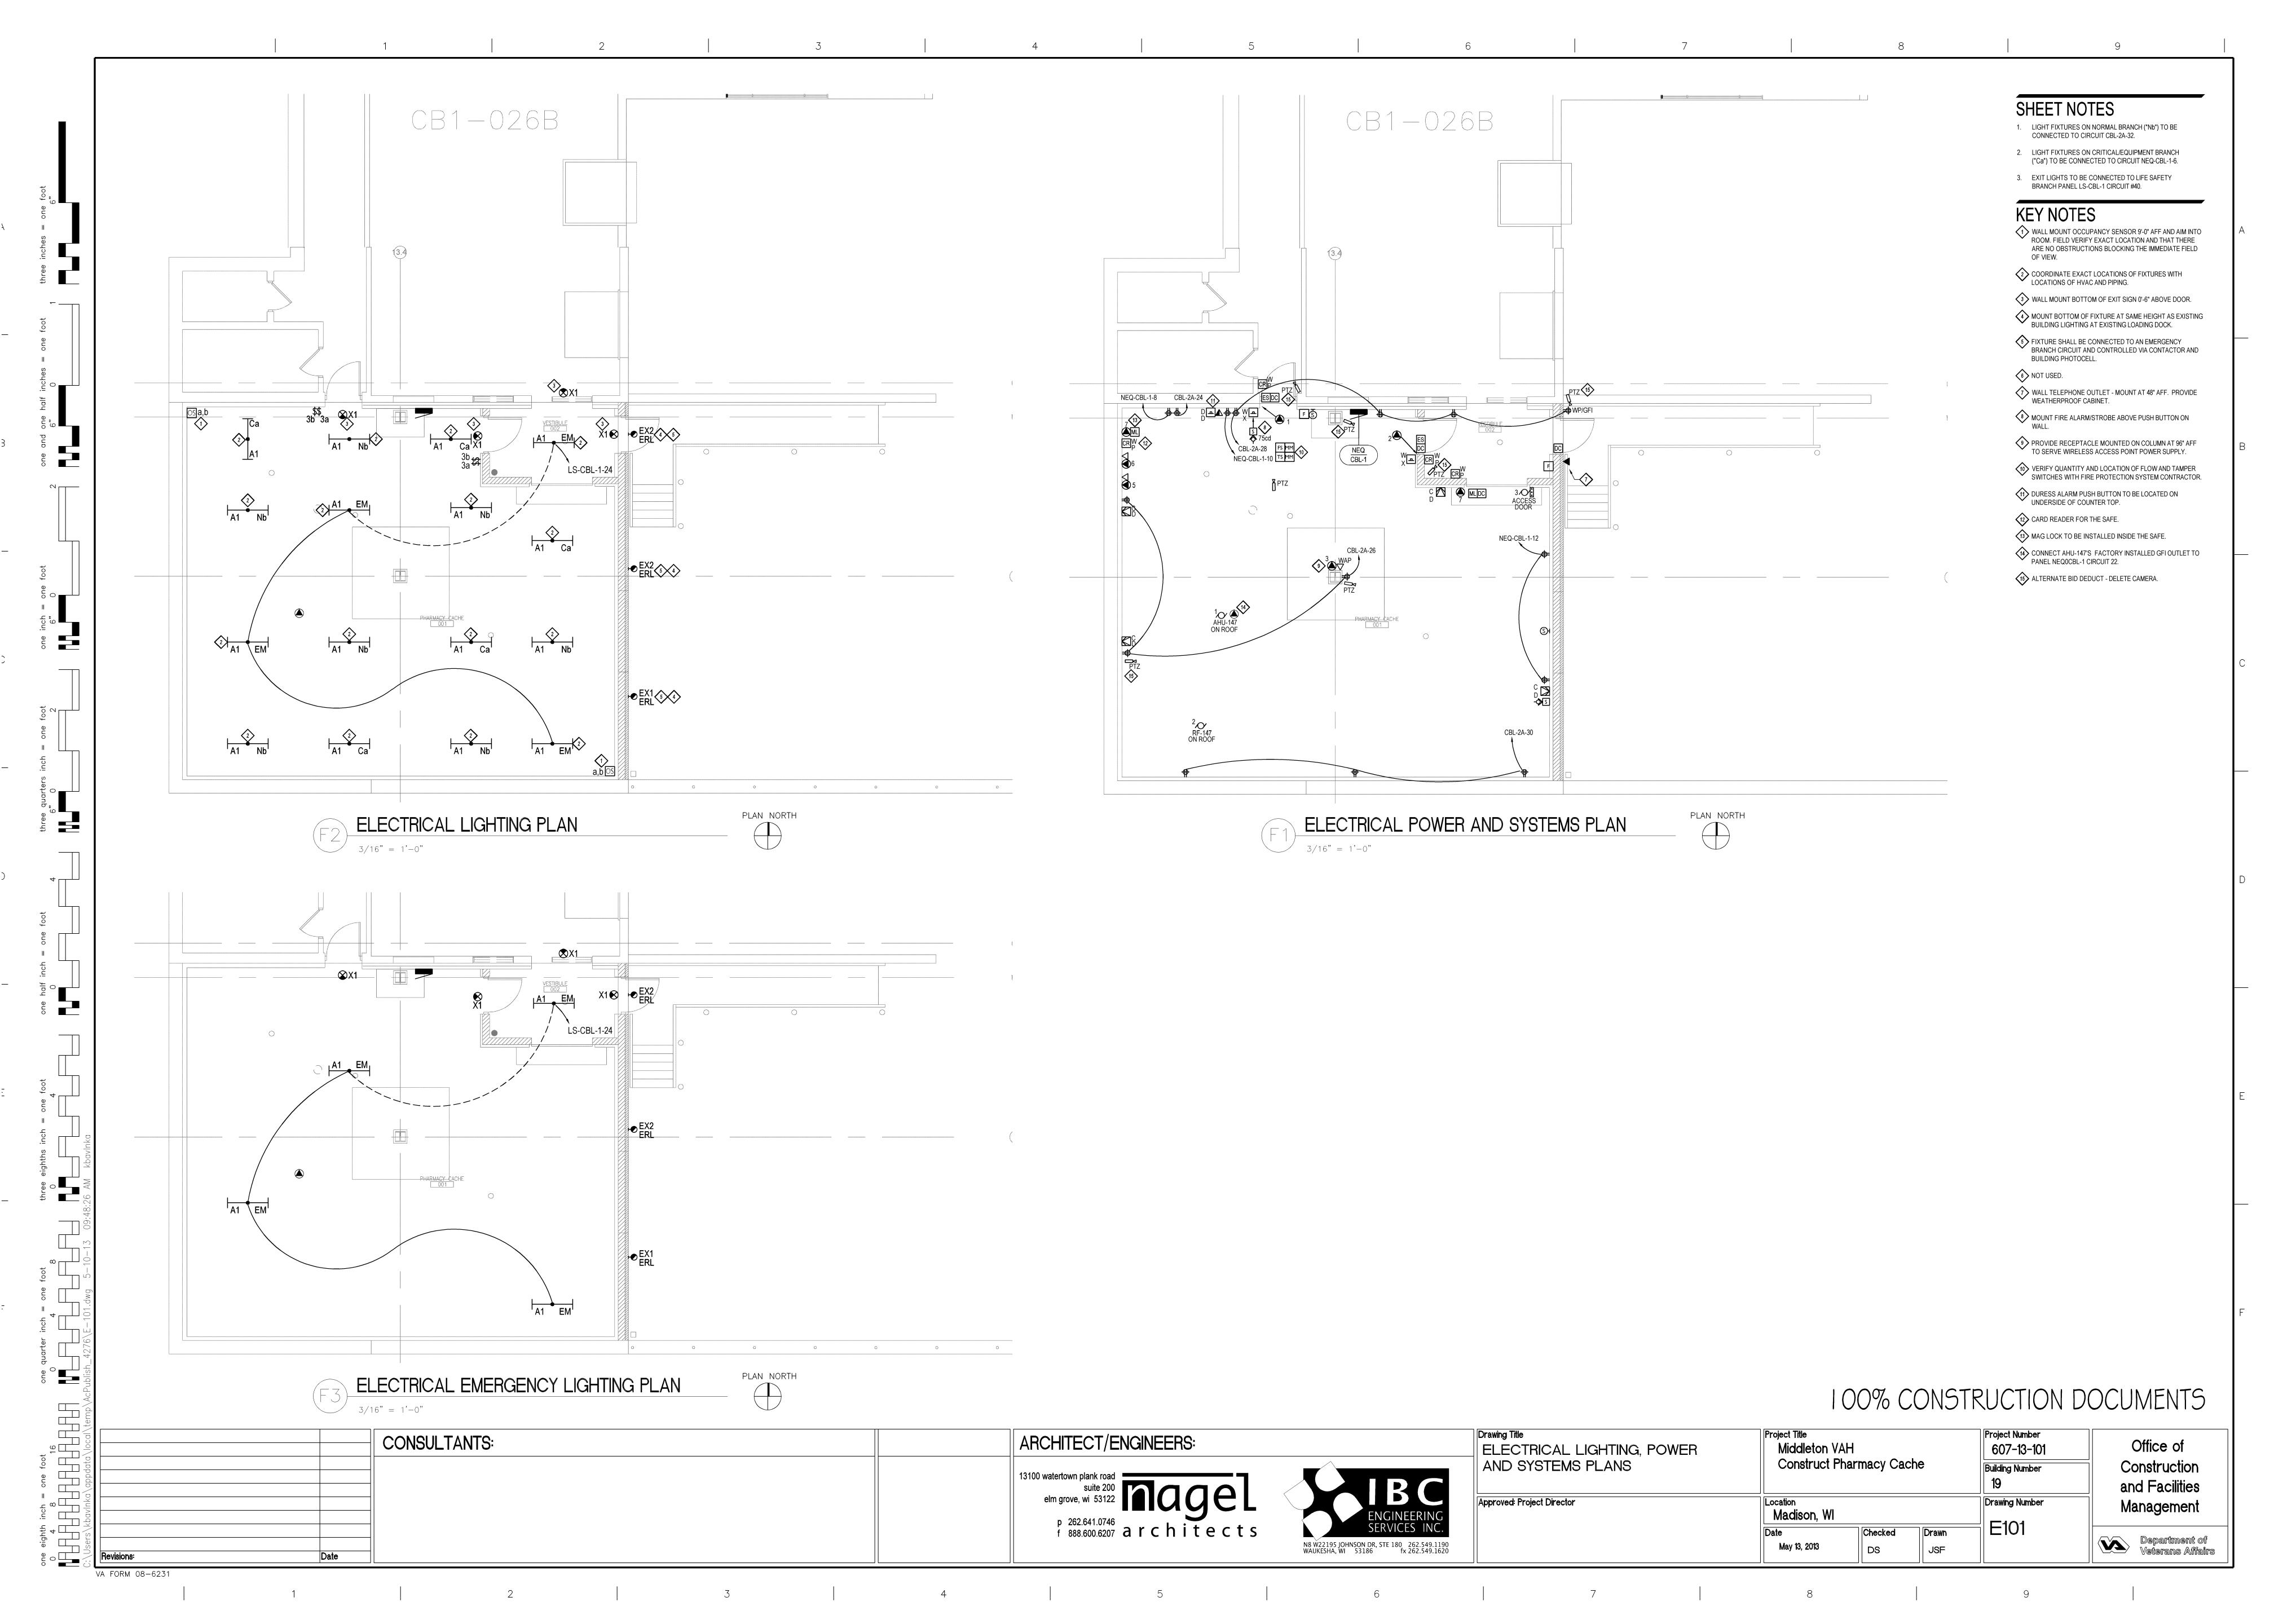
JSF

Madison, WI

Office of 607-13-101 Construction **Building Number** and Facilities Drawing Number Management E001

Department of Veterans Affairs



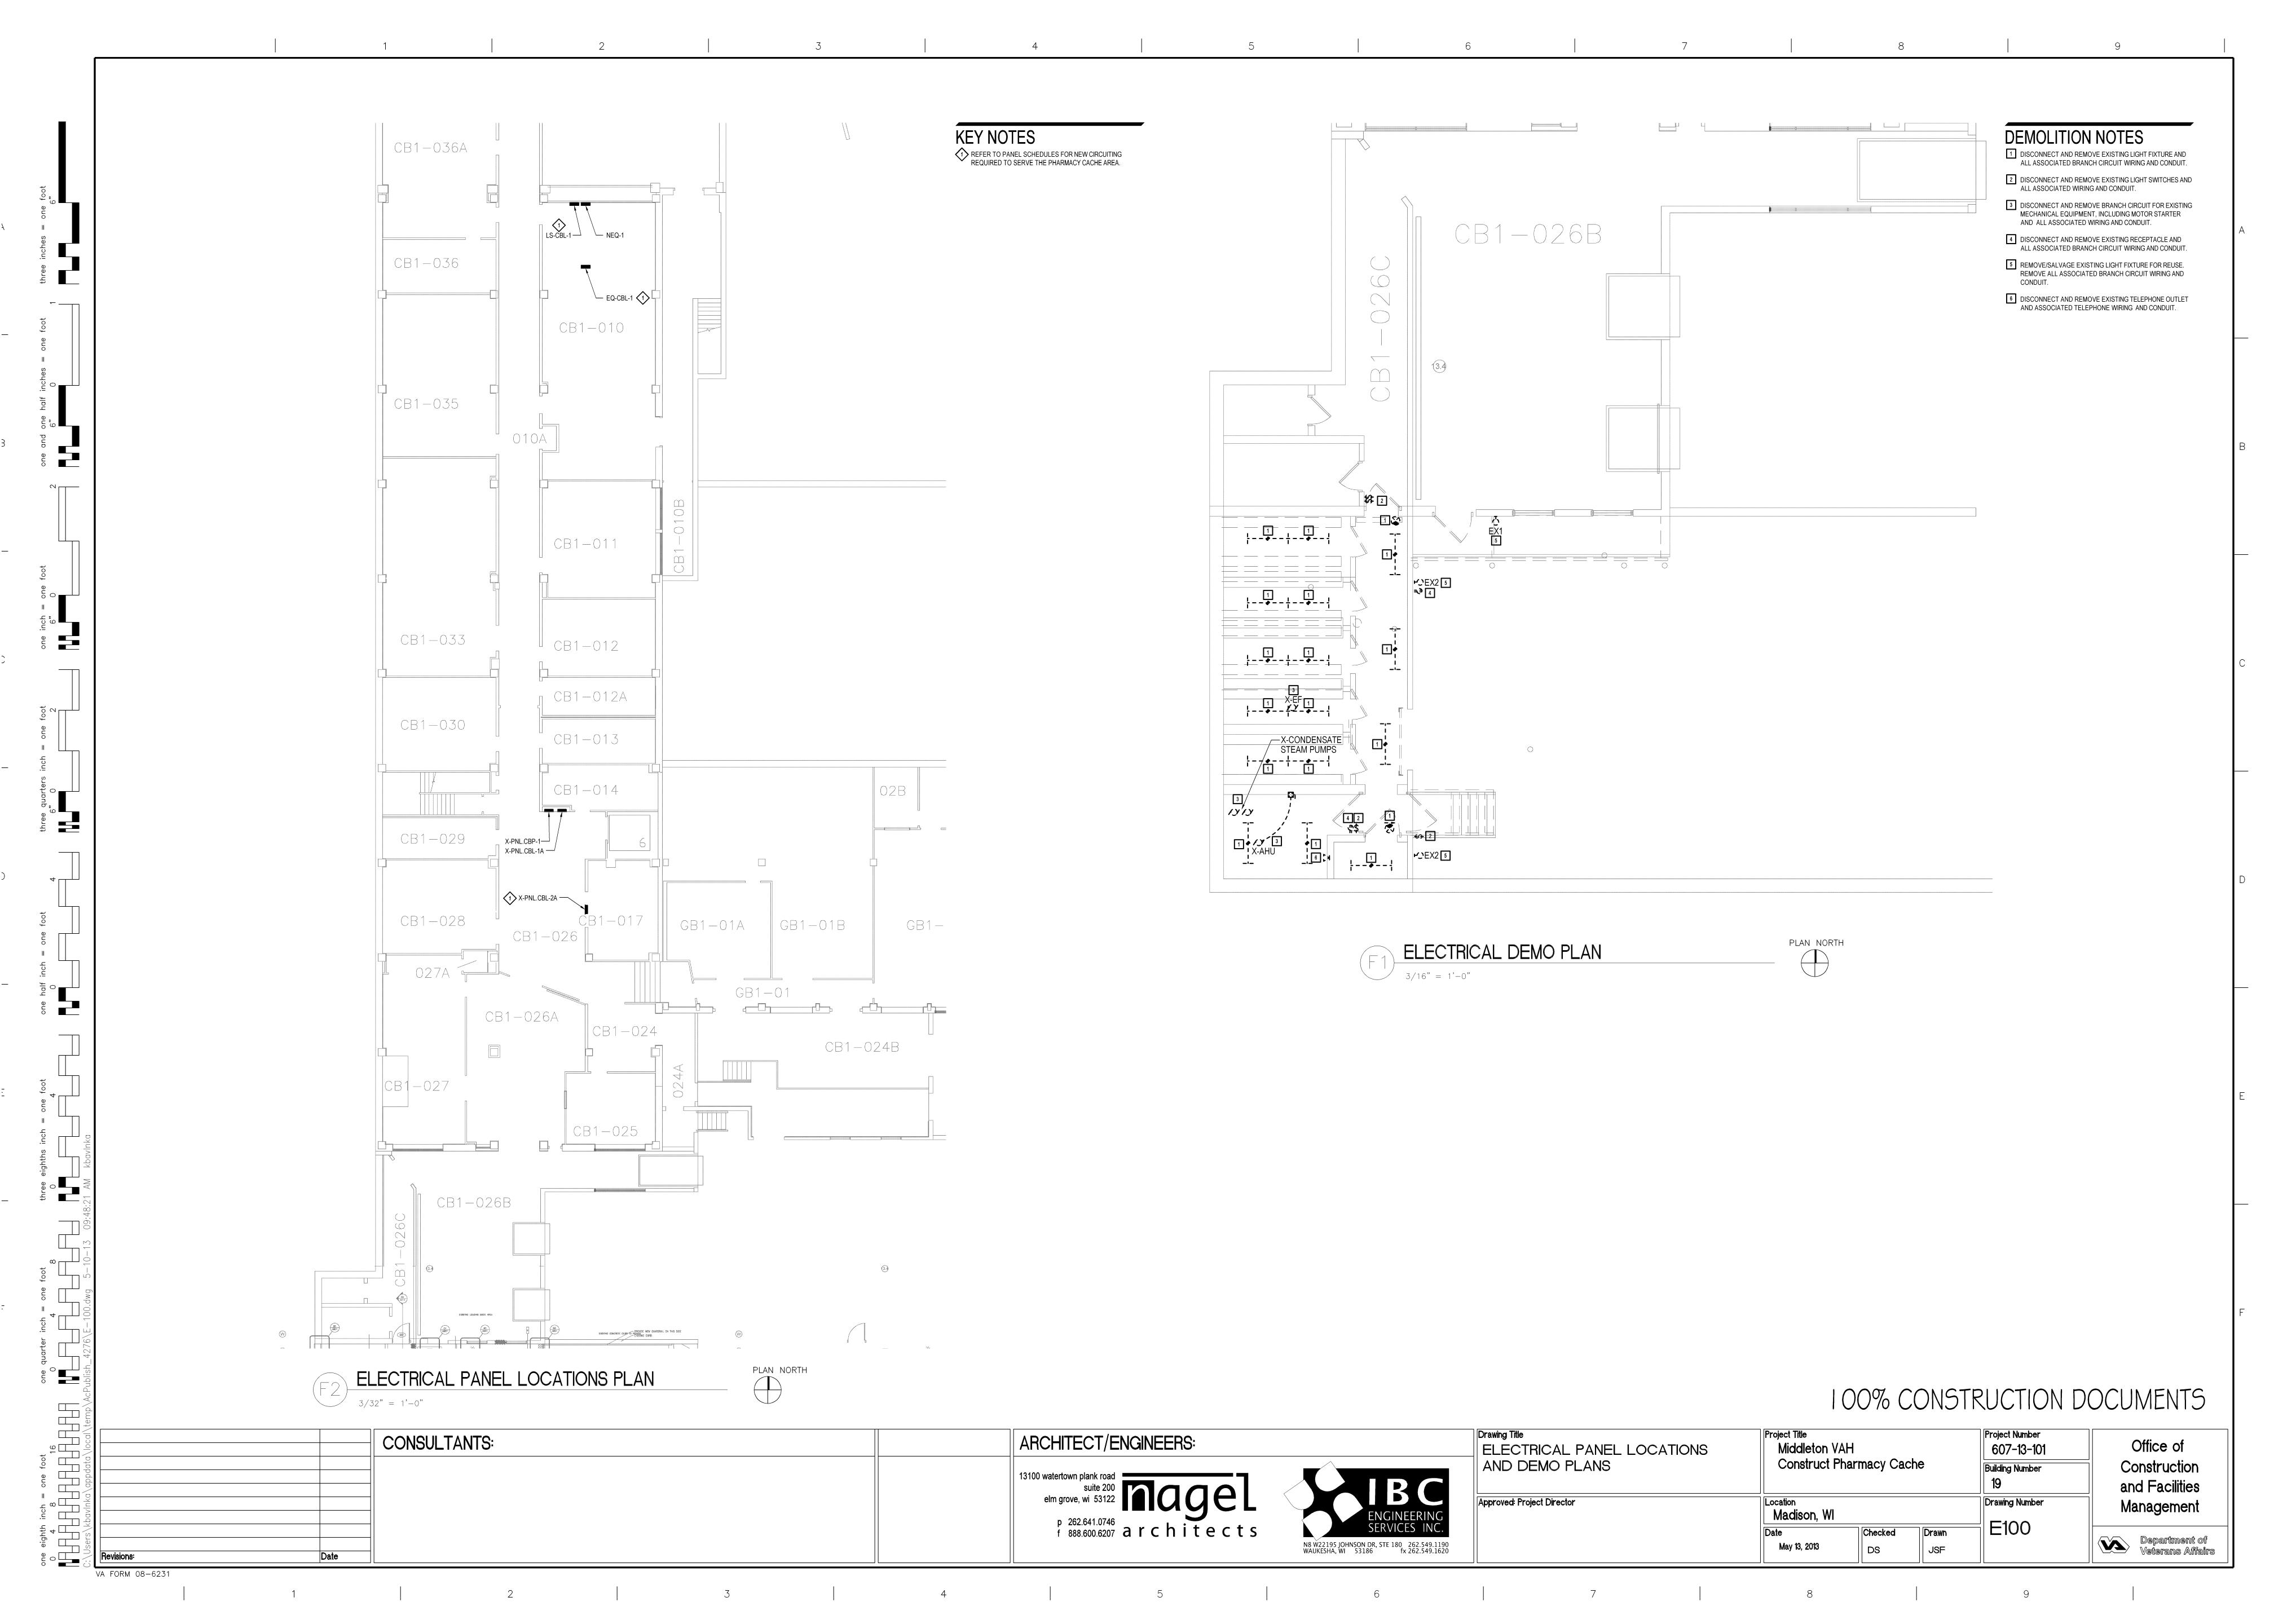

## SPECIAL PURPOSE OUTLET SCHEDULE

| MARK | TO FEED                | LOCATION     | KW    | FLA   | VOLT | PH | FEED F    | ROM | BREA | KER  |       | TYPE   |       | SEE  |
|------|------------------------|--------------|-------|-------|------|----|-----------|-----|------|------|-------|--------|-------|------|
|      |                        |              |       |       |      |    | PANEL     | CKT | SIZE | POLE | RECPT | DIRECT | OTHER | NOTE |
| 1    | DOOR LOCK POWER SUPPLY | PHARM. CACHE | 0.050 | 0.42  | 120  | 1  | LS-CBL-1  | 18  | 20   | 1    |       | Х      |       |      |
| 2    | DOOR LOCK POWER SUPPLY | PHARM. CACHE | 0.050 | 0.42  | 120  | 1  | LO-CDL-1  | 10  | 20   | '    |       | Х      |       |      |
| 3    | WIRELESS ACCESS POINT  | PHARM. CACHE | 0.015 | 0.125 | 120  | 1  | NEQ-CBL-1 | 14  | 20   | 1    | Χ     |        |       |      |
| 4    | NOT USED               | -            | -     | -     | -    | -  | -         | -   | _    | -    | -     | -      | -     |      |
| 5    | HVAC CONTROL PANEL     | PHARM. CACHE | 0.5   | -     | 120  | 1  | NEQ-CBL-1 | 18  | 15   | 1    |       | Х      |       |      |
| 6    | JACE CONTROL PANEL     | PHARM. CACHE | 0.5   | -     | 120  | 1  | NEQ-CBL-1 | 20  | 15   | 1    |       | Х      |       |      |
| 7    | MAG LOCK POWER SUPPLY  | PHARM. CACHE | 0.050 | 0.42  | 120  | 1  | NEQ-CBL-1 | 16  | 20   | 1    |       | Х      |       |      |
|      |                        |              |       |       |      |    |           |     |      |      |       |        |       |      |

## **MOTOR WIRING SCHEDULE**

|     |                           1 |  |         |
|-----|---------------------------|--------------|-----|--------|------|-----|-----------|----------|------|-------|---------|---------|-----|---------|------|------|------|------------|-------|------|---|--|---------|
| NO. | DRIVING                   | LOC.         | HP  | FLA    | VOLT | PH. | FEED      | FROM     | BRE  | EAKER |         | STARTER |     | STARTER |      |      |      | DISCONNECT |       |      |   |  | REMARKS |
|     |                           |              |     |        |      |     | PANEL     | CIRCUIT  | SIZE | POLE  | TYPE    | FURN    | INS | WIRED   | LOC. | TYPE | FURN | INS        | WIRED | LOC. |   |  |         |
| 1   | AIR HANDLING UNIT AHU-147 | PHARM. CACHE | 1   | 30 MCA | 208  | 3   | NEQ-CBL-1 | 1,3,5    | 45   | 3     | MAG     | MFR     | MFR | MFR     | IU   | DS   | MFR  | MFR        | MFR   | OU   |   |  |         |
| 2   | RELIEF FAN RF-1           | PHARM. CACHE | 1/6 | 4.4    | 120  | 1   | NEQ-CBL-1 | 2        | 15   | 1     | -       | -       | -   | -       | -    | DS   | MC   | EC         | EC    | NU   |   |  |         |
| 3   | ROLL-UP ACCESS DOOR       | PHARM. CACHE | 0.5 | 2.5    | 208  | 3   | NEQ-CBL-1 | 13,15,17 | 15   | 3     | MAG/REV | MFR     | MFR | MFR     | OU   | FD   | EC   | EC         | EC    | NU   |   |  |         |
|     |                           |     |                           
|       |  |     |                   | LIC   | SHTING          | FIXTURE S                  | CHEDU     | LE           |                                    |              |          |
|-------|--|-----|-------------------|-------|-----------------|----------------------------|-----------|--------------|------------------------------------|--------------|----------|
| FIVE  | DECODIDETION   |     | LAMPING           |       | \(\rightarrow\) |                            | 0511 1110 |              |                                    | 4.0050000150 |          |
| FIXT. | DESCRIPTION  | NO. | TYPE              | INPUT | VOLT            | MOUNT                      | CEILING   | MANUFACTURER | CATALOG NUMBER                     | ACCESSORIES  | SEE NOTE |
| A1    | 4' LED ENCLOSED INDUSTRIAL                                 | -   | 4170 LUMEN, 4100K | 59W   | 120V            | SURFACE                    | -         | LITHONIA     | VAP-59W-SYM                        |              | 5,6      |
| A1    | 4' FLUORESCENT ENCLOSED INDUSTRIAL                         | 2   | 32WT8             | 59W   | MVOLT           | SURFACE                    | -         | LITHONIA     | DMW-2-32WT8-MVOLT-GEBIOPS-STFL-BCD |              | 7        |
| EX1   |  |     |                   |       | RELOC           | ATED EXISTING EXTERIOR LIG | HT .      |              |                                    |              | 1        |
| EX2   |  |     |                   |       | RELOC           | ATED EXISTING EXTERIOR LIG | -tT       |              |                                    |              | 1        |
| X1    | SINGLE FACED, WALL MOUNTED EXIT SIGN - DAMP LOCATION RATED | -   | LED W/ UNIT       | 1W    | 120V            | SURFACE                    | VARIES    | LITHONIA     | LE-S-W-1-R-120277-DL               |              | 2,3,4    |


### LIGHTING FIXTURE SCHEDULE GENERAL NOTES:

- 1. CONTRACTOR SHALL CONFIRM CEILING TYPE REQUIREMENTS PRIOR TO THE RELEASE OF THE ORDER.
- 2. CATALOG NUMBERS ARE TO PROVIDE GUIDANCE ONLY AND MAY NOT BE COMPLETE.
- 3. FIXTURES SPECIFIED TO MEET DESIGN INTENT.
- 4. PROVIDE ALL EQUIPMENT AND ACCESSORIES NECESSARY FOR A COMPLETE AND FUNCTIONAL INSTALLATION.

### LIGHTING FIXTURE SCHEDULE KEY NOTES:

- 1. CLEAN, RELAMP AND REBALLAST FIXTURE PRIOR TO REINSTALLING IN NEW LOCATION. TOUCH UP PAINT IF NECESSARY.
- 2. FIELD SELECTABLE CHEVRONS SHALL BE APPLIED OR INSTALLED/REMOVED AS INDICATED ON PLANS AND AS REQUIRED BY ALL GOVERNING CODES.
- 3. PROVIDE NUMBER OF FACES AS INDICATED ON PLANS AND AS REQUIRED BY ALL GOVERNING CODES.
  4. ALL EXIT SIGNS MUST MEET ALL CITY, STATE, VA STANDARDS AND NATIONAL CODES INCLUDING BUT NOT LIMITED TO IBC 1011 AND ANSI-A117.1 SEC 703.
- 5. VERIFY FIXTURE MOUNT PRIOR TO ORDERING FIXTURES.
- 7 ALTERNATE DEDUCTIVE BID

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NOTE:

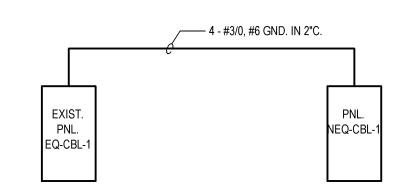1. REUSE EXISTING 200A/3P SPARE BREAKER IN EXISTING PANEL EQ-CBL-1 TO FEED NEW PANEL NEQ-CBL-1.



- 1)

|      |         |          |     |       |     |                   | PA            | NE | LL   | S-C  | BL     | -1 (I   | EXI | STING)           |                |     |       |     |      |       |      |
|------|---------|----------|-----|-------|-----|-------------------|---------------|----|------|------|--------|---------|-----|------------------|----------------|-----|-------|-----|------|-------|------|
| I    | MOUNT   | <u> </u> | SPA | ACES  | L   | OCATION           | VOLTAGE       | PH | WIRE | M    | AIN BU | S RATII | NG  | MCB              | MLO            |     | WIRE  |     |      | CONDU | IT   |
| (    | SURFACE | <u> </u> | 4   | 42    | R   | M. CB1-010        | 120/208       | 3  | 4    |      | 22     | 25A     |     | -                | 225A           |     | -     |     |      | -     |      |
| POLE | BRE     | AKER     |     | OUTLE | T   | DE                | SCRIPTION     |    | VA   | PHAS | SE LOA | ND VA   | VA  | DES              | SCRIPTION      |     | OUTLE | T   | BRE  | AKER  | POLE |
| NO.  | POLE    | AMP      | LGT | REC   | MIS |                   |               |    |      | Α    | В      | С       |     |                  |                | LGT | REC   | MIS | POLE | AMP   | NO.  |
| 1    | 1       | 20       |     |       |     | BASEMENT FL.      |               |    |      |      |        |         |     | EM. BASEMENT C   | ORR. LT.       |     |       |     | 1    | 20    | 2    |
| 3    | 1       | 20       |     |       |     | BASEMENT FL.      |               |    |      |      |        |         |     | BASEMENT EXIT I  | _T.            |     |       |     | 1    | 20    | 4    |
| 5    | 1       | 20       |     |       |     | HOSPITAL CLOC     | KS            |    |      |      |        |         |     | CODE ORANGE M    | ENTAL HYGIENE  |     |       |     | 1    | 20    | 6    |
| 7    | 1       | 20       |     |       |     | VISUAL PAGE       |               |    |      |      |        |         |     | JCI CONTROL PN   | L. B2          |     |       |     | 1    | 20    | 8    |
| 9    | 1       | 20       |     |       |     | BLOODBANK         |               |    |      |      |        |         |     | EM. LT. AUDITOR  | IUM            |     |       |     | 1    | 20    | 10   |
| 11   | 1       | 20       |     |       |     | REC. B1078 WES    | T WALL        |    |      |      |        |         |     | COMP. FIRE PRO   | TECTION        |     |       |     | 1    | 20    | 12   |
| 13   | 1       | 20       |     |       |     | REC. B1078 2 GA   | NG (S)        |    |      |      |        |         |     | EM. LT. C-010    |                |     |       |     | 1    | 20    | 14   |
| 15   | 1       | 20       |     |       |     | REC. B1078 2 GA   | NG (N)        |    |      |      |        |         |     | REC. & LT. N WAL | L C-010        |     |       |     | 1    | 20    | 16   |
| 17   | 1       | 20       |     |       |     | REC. C-036        |               |    |      |      |        | 100     | 100 | PHARMACY CACH    | IE DOOR LOCKS  |     |       | Х   | 1    | 20    | 18   |
| 19   |         |          |     |       |     | -                 |               |    |      |      |        |         |     | REC. C-013       |                |     |       |     | 1    | 20    | 20   |
| 21   | 3       | 40       |     |       |     | A/C C-120         |               |    |      |      |        |         |     | REC. C-013       |                |     |       |     | 1    | 20    | 22   |
| 23   |         |          |     |       |     | -                 |               |    |      |      |        | 236     | 236 | PHARMACY CACH    | HE EM. LIGHTS  | Х   |       |     | 1    | 20    | 24   |
| 25   | 1       | 20       |     |       |     | LT. B-07          |               |    |      |      |        |         |     | TIME CLOCK FIRE  | ALARM          |     |       |     | 1    | 20    | 26   |
| 27   | 1       | 20       |     |       |     | LT. TEL. RM. B-07 | 7A            |    |      |      |        |         |     | LT. PIPE STORAG  | ERM.           |     |       |     | 1    | 20    | 28   |
| 29   | 1       | 20       |     |       |     | LT. B-07          |               |    |      |      |        |         |     | LIGHTNING SUPP   | RESSOR         |     |       |     | 1    | 20    | 30   |
| 31   |         |          |     |       |     | -                 |               |    |      |      |        |         |     | LIGHTNING SUPP   | RESSOR         |     |       |     | 1    | 20    | 32   |
| 33   | 3       |          |     |       |     | SPARE             |               |    |      |      |        |         |     | LIGHTNING SUPP   | RESSOR         |     |       |     | 1    | 20    | 34   |
| 35   |         |          |     |       |     | -                 |               |    |      |      |        |         |     | 208 CB1-036AC    |                |     |       |     | 2    | 20    | 36   |
| 37   | 1       | 20       |     |       |     | SPARE             |               |    |      |      |        |         |     |                  |                |     |       |     |      |       | 38   |
| 39   | 1       | 20       |     |       |     | JOCKEY PUMP C     |               |    |      |      | 2      |         | 2   | PHARMACY CACH    | IE EXIT LIGHTS | Х   |       |     | 1    | 20    | 40   |
| 41   | 1       | 20       |     |       |     | FIRE ALARM C-03   | 35            |    |      |      |        |         |     | SPARE            |                |     |       |     | 1    | 20    | 42   |
|      |         |          |     |       |     |                   | PHASE TOTALS: |    |      |      | 2      | 336     |     | :PHASE           | TOTALS         |     |       |     |      |       |      |
|      |         |          |     |       |     |                   | TOTAL VA:     |    |      |      |        |         | 338 | :ТОТ:            | AL VA          |     |       |     |      |       |      |

|     | M OUN | T    | SPA | CES    | L   | OCATION      | VOLTAGE       | PH | WIRE | M    | AIN BU | S RATII | NG    | MCB             | MLO            |      | -   | WIRE  |     |      | CONDU | ĪT   |
|-----|-------|------|-----|--------|-----|--------------|---------------|----|------|------|--------|---------|-------|-----------------|----------------|------|-----|-------|-----|------|-------|------|
|     | FLUSH |      | 4:  | 2      | R   | M. CB1-026   | 120/208       | 3  | 4    |      | 20     | 00A     |       | 200A            | -              |      |     |       |     |      |       |      |
| OLE | BRE   | AKER | C   | OUTLET |     |              | DESCRIPTION   | •  | VA   | PHAS | SE LOA | AD VA   | VA    | DE              | SCRIPTION      |      | 0   | UTLET |     | BREA | KER   | POLE |
| NO. | POLE  | AMP  | LGT | REC    | MIS |              |               |    |      | Α    | В      | С       |       |                 |                | L    | .GT | REC   | MIS | POLE | AMP   | NO.  |
| 1   | 1     | 20   |     |        |     | P - C016 NOF | TH WALL       |    |      |      |        |         |       | RECYCLE ROOM    | BATTERY CHARG  | ER   |     |       |     | 1    | 20    | 2    |
| 3   | 1     | 20   |     |        |     | P - C016 EAS | T WALL        |    |      |      |        |         |       | RECYCLE ROOM    | HEATER BLOWER  |      |     |       |     | 1    | 20    | 4    |
| 5   | 1     | 20   |     |        |     | C016 SPARE   |               |    |      |      |        |         |       | RECYCLE ROOM    | POP CAN BOILER |      |     |       |     | 1    | 20    | 6    |
| 7   | 1     | 20   |     |        |     | C016 EAST W  | ALL           |    |      |      |        |         |       | A/C ROOM C-025  |                |      |     |       |     | 2    | 15    | 8    |
| 9   | 1     | 20   |     |        |     | P - C016 EAS | T WALL        |    |      |      |        |         |       | A/C NOON C-023  |                |      |     |       |     |      | 13    | 10   |
| 11  | 1     | 20   |     |        |     | P - C016 EAS | T WALL        |    |      |      |        |         |       |                 |                |      |     |       |     |      |       | 12   |
| 13  | 1     | 20   |     |        |     | P - C016 WES | T WALL        |    |      |      |        |         |       | SPARE TO CB1-02 | 27             |      |     |       |     | 3    | 20    | 14   |
| 15  | 1     | 20   |     |        |     | P - C016 WES | T WALL        |    |      |      |        |         |       |                 |                |      |     |       |     |      |       | 16   |
| 17  | 1     | 20   |     |        |     | P - C016 WES | T WALL        |    |      |      |        |         |       | BATTERY CHARG   | SER CB1-027    |      |     |       |     | 1    | 20    | 18   |
| 19  | 1     | 20   |     |        |     | SPARE        |               |    |      |      |        |         |       | BATTERY CHARG   | SER CB1-027    |      |     |       |     | 1    | 20    | 20   |
| 21  | 1     | 20   |     |        |     | SPARE        |               |    |      |      |        |         |       | BATTERY CHARG   | SER CB1-027    |      |     |       |     | 1    | 20    | 22   |
| 23  | 1     | 20   |     |        |     | SPARE        |               |    |      |      |        | 900     | 900   | PHARMACY CACI   | HE RECEPT REF  | RIG. |     | Х     |     | 1    | 20    | 24   |
| 25  | 1     | 20   |     |        |     | SPARE        |               |    |      | 540  |        |         | 540   | PHARMACY CACI   | HE RECEPTACLES | 6    |     | Х     |     | 1    | 20    | 26   |
| 27  | 1     | 20   |     |        |     | SPARE        |               |    |      |      | 720    |         | 720   | PHARMACY CACI   | HE RECEPTACLES | 6    |     | Х     |     | 1    | 20    | 28   |
| 29  | 1     | 20   |     |        |     | SPARE        |               |    |      |      |        | 540     | 540   | PHARMACY CACI   | HE RECEPTACLES | 6    |     | Х     |     | 1    | 20    | 30   |
| 31  | 1     | 20   |     |        |     | SPARE        |               |    |      | 418  |        |         | 418   | PHARMACY CACI   | HE LIGHTING    |      | Х   |       |     | 1    | 20    | 32   |
| 33  | 1     | 20   |     |        |     | SPARE        |               |    |      |      |        |         |       | SPARE           |                |      |     |       |     | 1    | 20    | 34   |
| 35  | 1     | 20   |     |        |     | SPARE        |               |    |      |      |        |         |       | SPARE           |                |      |     |       |     | 1    | 20    | 36   |
| 37  | 1     | 20   |     |        |     | SPARE        |               |    |      |      |        |         |       | SPARE           |                |      |     |       |     | 1    | 20    | 38   |
| 39  | 1     | 20   |     |        |     | SPARE        |               |    |      |      |        |         |       | SPARE           |                |      |     |       |     | 1    | 20    | 40   |
| 41  | 1     | 20   |     |        |     | SPARE        |               |    |      |      |        |         |       | SPARE           |                |      |     |       |     | 1    | 20    | 42   |
|     |       |      |     |        |     |              | PHASE TOTALS: |    |      | 958  | 720    | 1440    |       | :PHASE          | TOTALS         |      |     |       |     |      |       |      |
|     |       |      |     |        |     |              | TOTAL VA:     |    |      |      |        |         | 3,118 | :TOT:           | ΛΙ \/Λ         | 1    |     |       |     |      |       |      |

| PANEL NEQ-CBL-1 (NEW) |      |     |-----------------------|------|-----|--------|--------------|----------|---------------------------------------|---------------|------|--------|-----------------|------|------|-----------------|-------------------|-------------------|---------|-----|----------|------|------|----------|
| MOUNT                 |      |     | SPACES |              | LOCATION |                                       | VOLTAGE       | PH   | WIRE   | MAIN BUS RATING |      | MCB  | MLO             | WIRE              |                   | CONDUIT |     |          |      |      |          |
| SURFACE               |      | 42  |        | PHARM. CACHE |          | 120/208                               | 3             | 4    | 225A   |                 | 200A | -    | -               |                   | -                 |         |     |          |      |      |          |
| POLE BREAKER          |      | KER | OUTLE  |              | T        | DES                                   | SCRIPTION     | •    | VA     | PHASE LOAD VA   |      | VA   | DESCRIPTION     |                   | OUTLET            |         |     | BREAKER  |      | POLE |          |
| NO.                   | POLE | AMP | LGT    | REC          | MIS      |                                       |               |      |        | Α               | В    | С    |                 |                   |                   | LGT     | REC | MIS      | POLE | AMP  | NO.      |
| 1                     |      |     |        |              |          |                                       |               |      | 3122   | 3650            |      |      | 528             | RELIEF FAN RF-1   | (MTR. #2)         |         |     | Х        | 1    | 15   | 2        |
| 3<br>5                | 3    | 45  |        |              | X        | AIR HANDLING UNIT AHU-1 (MTR.#1)      |               | 3122 |        | 3122            |      |      | SPARE           |                   |                   |         |     | 1        | 20   | 4    |          |
|                       |      |     |        |              |          |                                       |               | 3122 |        |                 | 3493 | 371  | PHARMACY CACHE  | ELIGHTING         | Х                 |         |     | 1        | 20   | 6    |          |
| 7                     |      |     |        |              |          |                                       |               |      |        | 960             |      |      | 960             | PHARMACY CACHE    | E RECEPT REFRIG.  |         | Х   |          | 1    | 20   | 8        |
| 9                     |      |     |        |              |          |                                       |               |      |        |                 | 180  |      | 180             | PHARMACY CACHE    | E RECEPT COMPUTER |         | Х   |          | 1    | 20   | 10       |
| 11                    |      |     |        |              |          |                                       |               |      |        |                 |      | 360  | 360             | PHARMACY CACHE    | E RECEPTACLES     |         | Х   |          | 1    | 20   | 12       |
| 13                    |      | 15  |        |              |          | PHARMACY CACHE COILING DOOR (MTR. #3) |               | 288  | 303    |                 |      | 15   | WRELESS ACCESS  | S POINT (SPO #3)  |                   |         | Х   | 1        | 20   | 14   |          |
| 15                    | 3    |     |        |              | Х        |                                       |               | 288  |        | 388             |      | 100  | MAG LOCK POWER  | SUPPLIES (SPO #7) |                   |         | Х   | 1        | 20   | 16   |          |
| 17                    |      |     |        |              |          |                                       |               | 288  |        |                 | 788  | 500  | HVAC CONTROL PA | ANEL              |                   |         | Х   | 1        | 15   | 18   |          |
| 19                    |      |     |        |              |          |                                       |               |      |        | 500             |      |      | 500             | JACE CONTROL PA   | ANEL              |         |     | Х        | 1    | 15   | 20       |
| 21                    |      |     |        |              |          |                                       |               |      |        |                 | 180  |      | 180             | ROOF RECEPACLE    |                   |         | Х   |          | 1    | 20   | 22       |
| 23                    |      |     24       |
| 25                    |      |     26       |
| 27                    |      |     28       |
| 29                    |      |     30       |
| 31                    |      |     32       |
| 33                    |      |     34       |
| 35                    |      |     36       |
| 37                    |      |     |        |              |          |                                       |               | ·    |        |                 |      |      |                 |                   |                   |         |     |          |      |      | 38       |
| 39<br>41              |      |     40<br>42 |
| 71                    |      |     |        |              |          |                                       | PHASE TOTALS: |      |        | 5413            | 3870 | 4641 |                 | :PHASE T          | OTALS             |         |     | <u> </u> |      |      | 44       |
|                       |      |     |        |              |          |                                       | TOTAL VA:     |      | 10,230 |                 | 1    |      | 3,694           | :TOTA             |                   |         |     |          |      |      |          |

# 100% CONSTRUCTION DOCUMENTS

|          | CONSULTANTS: | ARCHITECT/ENGINEERS:                              | Drawing Title  ELECTRICAL SCHEDULES  | Project Title  Middleton VAH | Project Number 607-13-101 | Office of                      |  |
|----------|--------------|---|--------------------------------------|------------------------------|---------------------------|--------------------------------|--|
|          |              | 13100 watertown plank road                        |                                      | Construct Pharmacy Cache     | Building Number           | Construction and Facilities    |  |
|          |              | elm grove, wi 53122 and GeL                       | Approved: Project Director  INEERING | Location  Madison, WI        | Drawing Number            | Management                     |  |
|          |              | f 888.600.6207 architects SERV                    | ICES INC.                            | Date Checked Drawn           | E200                      | Department of                  |  |
| risions: | Date         | N8 W22195 JOHNSON DR, STE 1<br>WAUKESHA, WI 53186 | 180 262.549.1190<br>fx 262.549.1620  | May 13, 2013 DS JSF          |                           | Department of Veterans Affairs |  |

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